1.CONTRACTOR SHALL FIELD VERIFY AND CORRELATE ALL DIMENSIONS ON

2. FIELD VERIFY AND USE DIMENSIONS AS INDICATED. DO NOT SCALE DIMENSIONS FROM THE DRAWINGS.

3. CONTRACTOR TO LOCATE AND LAY-OUT ALL WALLS AND PARTITIONS AS THEY RELATE TO THE STRUCTURE AND OTHER BUILDING ELEMENTS AS SHOWN ON THE DRAWINGS, AND IN CONFORMANCE WITH THE DESIGN CONCEPT AND INTENT.

4. ALL FLOOR PLAN DIMENSIONS ARE TO THE FACE OF THE WOOD FRAME OR INTERIOR PARTITIONS OR FURRING ASSEMBLIES, GRID LINES OR THE CENTER LINE OF COLUMNS AND BEAMS; THE FACE OF MASONRY WALLS OR VENEERS; THE FACE OF WINDOWS FRAMES OR HOLLOW METAL DOOR FRAMES; THE EXPOSED FACE OF WOOD DOOR FRAMES (JAMBS) AT NOMINAL DOOR OPENINGS; UNLESS NOTED OTHERWISE, (U.N.O).

5. FLOOR PLAN DIMENSIONS AT EXTERIOR PERIMETER WALLS ARE TO THE FACE OF THE FRAMING AND AND DO NOT INCLUDE THE THICKNESSES OF THE EXTERIOR FINISH MATERIALS; FIBER CEMENT OR WOOD SIDING AND TRIM; STUCCO OR CEMENT PLASTER, AND/OR METAL WALL PANELS AND TRIM, OR OTHER MATERIALS AS INDICATED OR NOTED. FLOOR PLAN DIMENSIONS AT EXTERIOR PERIMETER CAVITY WALLS WITH MASONRY OR STONE VENEERS ARE TO THE FACE OF THE MASONRY OR STONE VENEERS AND THE EDGE OF THE CONCRETE SLAB FOUNDATION, UNLESS NOTED OR INDICATED OTHERWISE.

6. DIMENSIONS NOTED AS CLR. (CLEAR) AND O.T.O. (OUTSIDE TO OUTSIDE) ARE TO FINISH WALL OR PARTITIONS SURFACES.

7. PROVIDE CONCEALED WOOD BLOCKING, WOOD SUPPORT FRAMEWORK AND BRACING, AND ALL MISC. WOOD NAILERS, ETC., AS REQUIRED.

8. PROVIDE CONCEALED WOOD BLOCKING, CONTINUOUS, WHERE REQUIRED IN ALL WOOD STUD PARTITIONS FOR THE PROPER ANCHORAGE OF WALL ATTACHED ITEMS, SUCH AS MIRRORS, TOILET ACCESSORIES, FUTURE GRAB BARS, WALL-HUNG AND BASE CABINETS, COUNTERTOPS, WALL-HUNG LAVATORIES, CLOSET RODS, CLOSET LEDGER STRIPS AND SHELVES, METALS SHELF BRACKETS, OWNER PROVIDED CLOSET SYSTEM ITEMS, FIRE EXTINGUISHERS, BRACING AT CEILING FANS, AND ALL OTHER ITEMS OR MISCELLANEOUS EQUIPMENT.

9. ALL INTERIOR PARTITION WALLS EXTEND TO THE BOTTOM OF THE CEILING/ FLOOR FRAMING OR ROOF FRAMING, UNLESS NOTED OTHERWISE, AND BRACED TO THE STRUCTURE AS REQUIRES TO PREVENT MOVEMENT OR DEFLECTION.

10. ALL INTERIOR PARTITION WALLS EXTEND TO THE STRUCTURE OR THE BOTTOM OF CEILING/FLOOR FRAMING OR CEILING/ROOF FRAMING, UNLESS NOTED OR INDICATED OTHERWISE. ALL INTERIOR PARTITIONS THAT DO NOT EXTEND TO THE FRAMING SHALL BE BRACED TO THE STRUCTURE AS REQUIRED TO PREVENT MOVEMENT OR DEFLECTION.

11. NOTIFY THE ARCHITECT IMMEDIATELY OF DISCREPANCIES IN THE DRAWINGS, BETWEEN THE DRAWINGS AND SPECIFICATIONS, OR BETWEEN THE DRAWINGS AND ACTUAL JOB CONDITIONS WHICH AFFECT THE EXECUTION OF THE WORK AS INTENDED. THE ARCHITECT WILL ISSUE A CLARIFICATION OR PREPARE ALTERNATE DOCUMENTS WHICH MAY BE REQUIRED.

12. THE CONTRACTOR IS RESPONSIBLE FOR COORDINATING THE WORK OF ALL TRADES, FOR CHECKING AND COORDINATING ALL CONTRACT DOCUMENTS, SUBMITTALS, FIELD CONDITIONS AND DIMENSIONS FOR ACCURACY, AND CONFIRMING THAT THE WORK IS BUILDABLE AS SHOWN AND INTENDED, BEFORE PROCEEDING WITH CONSTRUCTION. IF THERE ARE QUESTIONS REGARDING THESE OR ANY OTHER COORDINATION ISSUES, THE CONTRACTOR IS RESPONSIBLE FOR OBTAINING CLARIFICATION FROM THE ARCHITECT REGARDING THE WORK, OR ANY RELATED WORK, IN QUESTION, BEFORE PROCEEDING WITH THE WORK.

13. AREA QUANTITIES NOTED ON THE PLAN DRAWINGS ARE PROVIDED FOR INFORMATION PURPOSES ONLY. CONTRACTOR IS RESPONSIBLE FOR FIELD VERIFICATION OF ALL DIMENSIONS AND AREA CALCULATIONS UTILIZED TO DETERMINE HIS COSTS AND QUANTITIES NECESSARY TO PROVIDE ALL LABOR, MATERIALS, COMPONENTS, AND ACCESSORIES REQUIRED TO COMPLETE WORK.

14. DIMENSIONS SHOWN ARE FOR ROUGH OPENINGS; FRAMERS SHALL ALLOW NOMINAL OPENING CLEARANCES AS REOUIRED.

15. 12" FLASHING TAPE (PEEL & STICK MEMBRANE). TO BE APPLIED TO SEAL ALL CORNERS AND OPENINGS OF THE BUILDING

VISITABILITY NOTES

1. IN ACCORDANCE WITH R320.6 OF THE VISITABILITY ORDINANCE NO.20140130-021, PROVIDE ONE NO STEP ENTRANCE WITH A BEVELED THRESHOLD OF $\frac{1}{2}$ " OR LESS AND A MINIMUM 32" CLEAR OPENING DOOR.

2. IN ACCORDANCE WITH R320.3 OF THE VISITABILITY ORDINANCE NO.20140130-021, PROVIDE VISITABLE BATHROOM WITH MINIMUM CLEAR OPENING OF 30 INCHES, LATERAL 2X6 OR LARGER WOOD BLOCKING INSTALLED FLUSH WITH STUD EDGES OF BATHROOM WALLS, AND CENTERLINE OF BLOCKING MUST BE 34: FROM AND PARALLEL TO INTERIOR FLOOR LEVEL, EXCEPT PORTION DIRECTLY BEHIND THE LAVATORY.

3. IN ACCORDANCE WITH R320.4 OF THE VISITABILITY ORDINANCE NO.20140130-021, FIRST FLOOR LIGHT SWITCHES AND ENVIRONMENTAL CONTROLS TO BE PLACED AT A MAXIMUM OF 48" ABOVE FINISH FLOOR, OUTLETS AND RECEPTACLES MUST BE A MINIMUM OF 15" ABOVE FINISH FLOOR, EXCEPT FLOOR OUTLETS AND RECEPTACLES.

4. IN ACCORDANCE WITH R320.5 OF THE VISITABILITY ORDINANCE NO.20140130-021, PROVIDE MINIMUM 32" CLEAR PATH ACCESS STARTING FROM ENTRANCE (R320.6) AND ALLOWING ACCESS THROUGHOUT FIRST FLOOR AND TO THE FIRST FLOOR BATHROOM DESIGNATED UNDER R320.3

5. IN ACCORDANCE WITH R320.7 OF THE VISITABILITY ORDINANCE NO.20140130-021, PROVIDE A VISIBLE ENTRANCE APPROVED UNDER SECTION R320.6 MUST HAVE AT LEAST ONE VISITABLE ROUTE WITH A CROSS SLOPE OF NO GREATER THAN TWO PERCENT (1:50) THAT ORIGINATES FROM A GARAGE, DRIVEWAY, PUBLIC STREET, OR PUBLIC SIDEWALK. A RAMP INCLUDED IN AN EXTERIOR VISITABLE ROUTE MUST COMPLY WITH THE RESIDENTIAL CODE

RCP NOTES

1. CONTRACTOR SHALL FIELD VERIFY AND CORRELATE ALL DIMENSIONS ON THE JOBSITE.

2. DIMENSIONS INDICATED ON THE REFLECTED CEILING PLAN ARE TO THE FACE OF GYPSUM BOARD PARTITIONS OR FURRING ASSEMBLIES, THE FACE OF MASONRY SURFACES, WINDOWS FRAMES, AND GRID LINES, AND TO THE CENTER LINE OF LIGHT FIXTURES, CEILING FANS, SUPPLY AIR DIFFUSERS, EXHAUST AND RETURN AIR GRILLES, ETC., UNLESS NOTED OTHERWISE.

3. CONTRACTOR TO LOCATE AND LAYOUT CEILING SYSTEM AND CEILING MOUNTED FIXTURES AND OTHER ITEMS AS THEY RELATE TO THE STRUCTURE AND OTHER BUILDING ELEMENTS AS SHOWN ON THE DRAWINGS, AND IN CONFORMANCE WITH THE DESIGN CONCEPT AND INTENT.

4. CEILING MOUNTED ELEMENTS, RECESSED LIGHT FIXTURES, MECHANICAL DIFFUSERS AND GRILLES, SPEAKERS, SMOKE DETECTORS, CEILING FANS, SURFACE MOUNTED TRACK LIGHTING SYSTEMS, ETC., SHALL BE CENTERED IN EACH ROOM, UNLESS NOTED OTHERWISE.

5. REFER TO THE MECHANICAL AND ELECTRICAL PLAN SYMBOL SCHEDULES.

6. REFER TO THE ROOM FINISH SCHEDULE FOR CEILING SYSTEM MATERIALS AND FINISHES. CEILING HEIGHTS ARE NOTED ON THE FLOOR AND THE REFLECTED CEILING PLANS AND THE BUILDING SECTIONS.

7. COORDINATE ALL WORK WITH OTHER TRADES. REFER TO THE PLUMBING, MECHANICAL AND ELECTRICAL DRAWINGS AS REQUIRED.

8. TYPICAL CEILINGS TO BE PAINTED GYPSUM BOARD CEILING SYSTEM, UNLESS NOTED OTHERWISE, WITH CEILING OFFSETS AND FURR DOWNS AS INDICATED.

9. PROVIDE RECESSED FLUSH MOUNTED ACCESS PANELS TO PLUMBING, MECHANICAL AND ELECTRICAL EQUIPMENT LOCATED ABOVE THE FINISH CEILING IN ALL SUSPENDED GYPSUM BOARD CEILINGS AS REQUIRED.

10. NOTIFY ARCHITECT FOR OBSERVATION OF THE ABOVE CEILING MEP WORK PRIOR TO THE INSTALLATION OF GYPSUM BOARD CEILINGS.

11. USE 2"X4" FRAMING FOR ALL FURR DOWNS.

ELECTRICAL NOTES

DESIGN AND FURNISH 1. LAYOUT SHOWN IS SCHEMATIC ONLY. ELECTRICAL CONTRACTOR SHALL ELECTRICAL SYSTEM IN CONFORMANCE WITH ALL APPLICABLE CODES.

2. COORDINATE WITH HVAC INSTALLER TO PROVIDE POWER FOR ALL MECHANICAL UNITS.

LOCATION WITH BUILDING 3. PROVIDE NEW DISTRIBUTION PANELS AS REQUIRED, COORDINATE DESIGNER.

4. COORDINATE WITH PLUMBING CONTRACTOR TO PROVIDE POWER FOR TANK-LESS WATER HEATER WITH ELECTRIC IGNITION CONTROLS, GARBAGE DISPOSALS, EJECTOR AND OTHER EQUIPMENT WHERE INDICATED OR NOTED.

5. VERIFY POWER REQUIREMENT FOR APPLIANCES WITH ARCHITECT/GENERAL CONTRACTOR.

6. BUILDING SERVICE TO ELECTRICAL PANELS SHALL BE OVERHEAD.

7. CONDUCTORS: COPPER, ROMEX, INSULATED UL APPROVED, PER COA CODE AND NEC.

8. PANELS, SWITCHGEAR: MAIN DISTRIBUTION PANELS SHALL BE EQUIPPED WITH APPROPRIATE NUMBER AND SIZE OF CIRCUIT BREAKERS/ PROVIDE MIN. OF FOUR SPARES, BLANK WITHOUT CIRCUIT BREAKERS.

9. PROVIDE DIRECTORY IDENTIFYING ALL CIRCUITS AND ROOM NAMES FOR COMPLETED ELECTRICAL SYSTEM, MOUNTED ON INSIDE FRONT CORNER OF PANEL

10. OUTLET BOXES AND BOXES FOR LIGHT FIXTURES AND SWITCH BOXES SHALL BE PLASTIC, UL APPROVED, PER COA CODE, BY PASS AND SEYMOUR OR EQUAL, PROVIDE SPECIAL GALVANIZED METAL BOXES FOR CEILING FANS. PROVIDE GALVANIZED METAL BOXES IN MASONRY OR CEMENT PLASTER WALLS.

11. WIRING DEVICES: SWITCHES AND RECEPTACLES; UL APPROVED BY PASS AND SEYMOUR OR EQUAL. SWITCHES SHALL BE SILENT TYPE. DECORATOR SWITCHES APPROVED BY ARCHITECT. DIMMER SWITCHES, UL APPROVED BY LUTRON, TYPE APPROVED BY ARCHITECT

12. DEVICE PLATES: PLASTIC, BY PASS AND SEYMOUR OR LUTRON, OR EQUAL, COLOR APPROVED BY ARCHITECT.

13. IN GENERAL, WALL OUTLET BOXES FOR RECEPTACLES SHALL BE MOUNTED AT 15" AFF TO CENTERLINE, TYPICAL AND BOXES FOR SWITCHES AND DIMMERS SHALL BE MOUNTED AT 48" AFF TO CENTERLINE. TYPICAL.

14. FIELD VERIFY AND COORDINATE WITH ARCHITECT REGARDING MOUNTING HEIGHTS AND LOCATIONS AND FINISH THICKNESSES FOR OUTLET BOXES AT KITCHEN AND BATHROOM CABINETS AND COUNTERTOPS, BACK AND END SPLASHES, AND OTHER SPECIAL CONDITIONS.

15. ALL OUTLETS IN ALL LOCATIONS SHOULD BE ARC FAULT PER 210.12 OF NFPA 70 (IBC 2012), UNLESS NOTED OTHERWISE.

16. ALL OUTLETS IN BATHROOMS, LAUNDRY ROOMS, GARAGES, ACCESSORY BUILDINGS AND EXTERIOR TO BE GROUND-FAULT CIRCUIT INTERRUPT. AS WELL AS ALL LOCATIONS IN A KITCHEN THAT SERVICE COUNTERTOP SURFACES AND WITHIN 6FT OF THE EDGE OF SINK, BATHTUB, OR SHOWER STALL.

17. ALL OUTDOOR OUTLETS AND LIGHTS SHOULD BE ON A GROUND FAULT BREAKER.

PLUMBING NOTES

 CONTRACTOR SHALL VERIFY AND COORDINATE THE EXACT LOCATION OF PIPING, FITTINGS, OFFSETS, BENDS, DEVICES AND EQUIPMENT WITH EXISTING SITE CONDITIONS, THE BUILDING ELEMENTS AND THE WORK OF OTHER TRADES.

2. ALL WORK, INCLUDING MATERIALS AND WORKMANSHIP, SHALL CONFORM TO THE REQUIREMENTS OF LOCAL CODES, LAWS AND ORDINANCES, THE UNIFORM MECHANICAL, PLUMBING AND BUILDING CODES, THE WORK SHALL BE COMPLETE IN ALL RESPECTS AND IN ACCORDANCE WITH ACCEPTED AND ESTABLISHED CONSTRUCTION PRACTICES.

3. THE COLD AND HOT WATER PLUMBING SYSTEMS ARE NOT SHOWN ON THE DRAWINGS.

4. WATER HEATER: NATURAL GAS WHOLE HOUSE TANK-LESS WATER HEATER, OUTDOOR INSTALLATION, VENT-LESS, ENERGY EFFICIENT, FREEZE PROTECTION TO FIVE DEGREES FAHRENHEIT, ELECTRONIC IGNITION, OPTIONAL REMOTE THERMOSTAT. ENDLESS HOTWATER SUPPLY FOR 2 MAJOR APPLICATIONS AT A TIME. MODEL: "AQUASTAR 2400EONG" BY BOSCH. OR "AQUASTAR 2505X0NG" OR APPROVED EQUAL OR RINNAI MODEL # R85E (2532W)

5. WATER SYSTEM PIPING: PEX, CROSS-LINKED FLEXIBLE, POLYETHYLENE PLASTIC PIPING WITH HIGH TEMPERATURE POLYMER FITINGS PROVIDE 1" THICK FOAM INSULATION AT ALL HOT WATER PIPING, AND 1/2" THICK AT ALL COLD WATER PIPING ABOVE THE SLAB, INCLUDING UNDER THE CONCRETE SLAB. PROVIDE CONTINUOUS PLASTIC SHEATHING AT ALL WATER SYSTEM PIPING PLACED BENEATH THE SLAB; COLOR CODED TO PROTECT THE TUBING - NOT SHOWN IN THIS PLAN.

6. WATER SYSTEM PIPING SHALL BE INSTALLED UNDERNEATH THE VAPOR BARRIER MEMBRANE FOR THE CONCRETE SLAB. NO JOINTS IN THE PIPING OR TUBING BENEATH THE SLAB ARE PERMITTED

7. WASTE WATER DRAIN AND VENT PIPING: PVC, SCHEDULE 40.

MECHANICAL NOTES

SYMBOL LEGEND:

DH=X'-Y" -

WINDOW SYMBOL

′ wx \

\AX.X/

DOOR SYMBOL

DXX

X.XA

1. HVAC SPLIT SYSTEM NOMINAL CAPACITY IS ESTIMATED AT 3 TONS (PER UNIT), WITH 1 AIR HANDLING UNIT AND 1 CONDENSING UNIT. SYSTEM DESIGN: MULTI-POSITION BLOWER WITH HEAT PUMP OUTDOOR CONDENSING UNIT.

2. HVAC SYSTEM DUCTWORK CONSTRUCTION SHALL BE REINFORCED FOIL FACED SEMI-RIGID GLASS FIBER DUCTS (SQUARE, RECTANGULAR). WITH FLEX DUCT CONNECTIONS AT MOST REGISTERS OR DIFFUSERS. SUPPLY AIR AND RETURN AIR DUCTWORK SHALL BE MINIMUM R-8 INSULATION. FLEX DUCTWORK CONNECTIONS SHALL ALSO BE RATED MINIMUM R-8.

3. PROVIDE ENERGY EFFICIENT AIR HANDLING AND CONDENSING UNITS WITH MINIMUM 14 SEER. COMPLY WITH COA STANDARDS.

4. HIGH QUALITY RESIDENTIAL SUPPLY DIFFUSERS AND RETURN AIR GRILLES, AS APPROVED BY THE OWNER, SHALL BE PROVIDED. STAMPED METAL GRILLES WILL NOT BE ACCEPTABLE.

5. VIBRATION ISOLATION AT THE AIR HANDLING UNIT SHALL BE PROVIDED, UTILIZING MINIMUM OF 4 -1" THICK RUBBER ISOLATION PADS.

6. MECHANICAL DESIGN/BUILD CONTRACTOR TO SUBMIT SHOP DRAWINGS AND PRODUCT DATA INFORMATION, PRIOR TO ORDERING EQUIPMENT OR MATERIALS, FOR APPROVAL BY THE OWNER AND ARCHITECT, DESCRIBING ALL OF THE MECHANICAL EQUIPMENT, DUCTWORK, INSULATION, PIPING, DIFFUSERS, GRILLES AND REGISTERS, THERMOSTATS, ACCESSORIES AND OTHER ITEMS REQUIRED TO COMPLETE THE MECHANICAL SYSTEM WORK. INDICATE ALL DUCTWORK CONSTRUCTION MATERIALS, DUCT SIZES AND AIR VOLUME CAPACITIES IN CFM AT ALL DIFFUSERS, GRILLES AND REGISTERS, TURNING VANES, LOCATIONS OF FLEX AND FIXED CONNECTIONS, VIBRATION ISOLATION DEVICES, AND OTHER APPLICABLE INFORMATION.

WINDOW NUMBER

CONCEALED HEADER

SHEET NUMBER

WINDOW NUMBER

- DROPPED HEADER

SHEET NUMBER

DOOR NUMBER

SHEET NUMBER

HEIGHT

BUILDING SECTION SYMBOL


PARTITION TYPE SYMBOL

—— SECTION NUMBER

SHEET NUMBER


-PARTITION NUMBER

-SHEET NUMBER

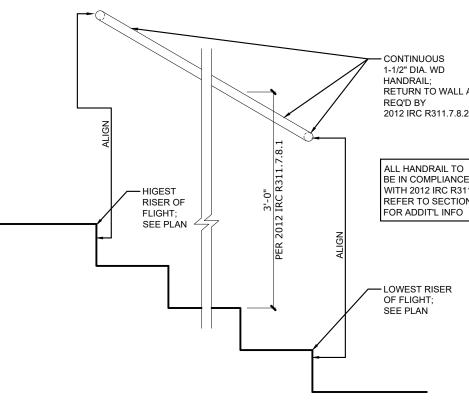


TYPICAL HANDRAIL DETAIL

SIZE SCALE: 3/4"=1'-0" HALF SIZE SCALE: 3/8"=1'-0"

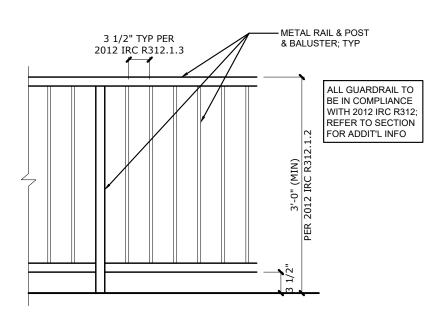


TYPICAL GUARDRAIL DETAIL 3


FULL SIZE SCALE: 3/4"=1'-0" HALF SIZE SCALE: 3/8"=1'-0"

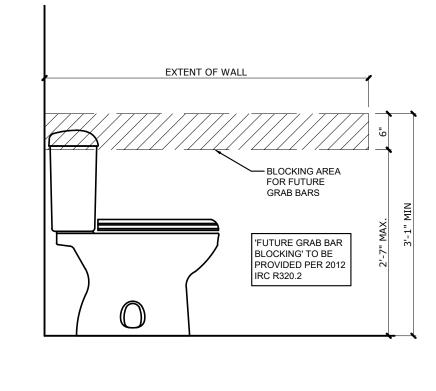

TYP ADA BLOCKING @ TOILET DETAIL FULL SIZE SCALE: 3/4"=1'-0" HALF SIZE SCALE: 3/8"=1'-0"

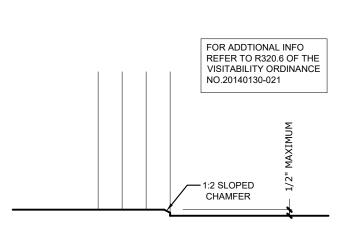

ADA COMPLIANT ENTRANCE FULL SIZE SCALE: 1-1/2"=1'-0 HALF SIZE SCALE: 3/4"=1'-0"

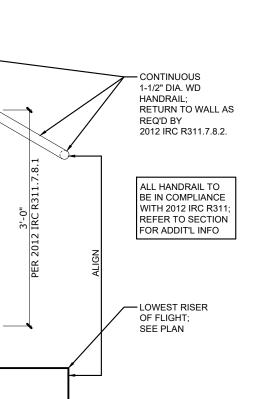

SEAL & SIGNATURE

PROJECT

OWNER

REVISIONS


NOTES

ISSUE

1112 S 5TH STREET

AUSTIN LUXURY BUILDERS

DATE

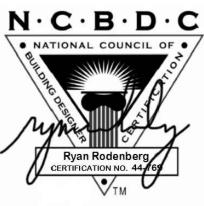

DESIGNER

RODENBERG DESIGN

1702 EVERGREEN DR AUSTIN, TX 78704 512-796-5995 RYAN@RODENBERGDESIGN.COM

STRUCTURAL ENGINEER

SEC SOLUTIONS LLC MARCOS DEQUEIROGA, PE **407 FOREST STREET** LIBERTY HILL, TX 78642 512-215-4364

SHEET TITLE

GENERAL NOTES

VERIFY SIZES AND HEAD HEIGHT W/ PLANS AND ELEVATIONS; CONTACT DESIGNER W/ ANY DISCREPANCIES: TEMPER NOT SPECIFIED

	SCHEDULE		T		
WINDOW #	SIZE	HEAD HEIGHT	TYPE	COMMENTS	
Α	4'0"X9'0"	9'0"	FIXED		
В	4'0"X9'0"	9'0"	FIXED		
С	9'0"X7'0"	8'0"	FIXED		
D	3'0"X7'0"	8'0"	FIXED		
E	3'0"X7'0"	8'0"	FIXED		
F	6'0"X5'0"	9'0"	FIXED		
G	3'0"X5'0"	8'0"	CASEMENT	EGRESS	
Н	4'0"X5'0"	8'0"	FIXED		
I	6'0"X8'0"	9'0"	FIXED		
J	6'0"X8'0"	9'0"	FIXED		
K	3'0"X4'0"	8'0"	FIXED		
L	4'0"X5'0"	8'0"	FIXED		
М	3'0"X5'0"	8'0"	CASEMENT	EGRESS	
N	3'0"X6'0"	8'0"	FIXED		
0	4'0"X6'0"	8'0"	FIXED		
Р	3'0"X6'0"	8'0"	CASEMENT	EGRESS	
Q	6'0"X7'0"	8'0"	FIXED		
R	3'0"X4'0"	8'0"	FIXED		
S	3'0"X8'0"	9'0"	FIXED		
Т	3'0"X8'0"	9'0"	FIXED		
U					
V					
W					
X					
Υ					
Z					
AA					
ВВ					
СС					
DD					
EE					

DOOR #	SIZE	INT / EX	COMMENTS	
1	8'0"X8'0"	EX	GARAGE	
2	3'0"X8'0"	EX		
3	3'0"X8'0"	EX	ACCESSIBLE ROUTE DOOR - ADA THRESHOLD	
4	2'8"X8'0"	INT	ACCESSIBLE ROUTE DOOR	
5	3'0"X9'0"	EX	FULL LITE.	
6	12'0"X9'0"	EX	3 PANEL SLIDER	
7	2'4"X8'0"	INT		
8	4'0"X8'0"	INT	DOUBLE DOORS	
9	2'8"X8'0"	INT		
10	2'4"X8'0"	INT		
11	2'6"X8'0"	INT	POCKET DOOR	
12	-			
13	2'6"X8'0"	INT		
14	2'4"X8'0"	INT		
15	2'8"X8'0"	INT		
16	2'6"X8'0"	INT		
17	2'6"X8'0"	INT	POCKET DOOR	
18	4'0"X8'0"	INT	DOUBLE DOORS	
19	6'0"X6'8"	EX	2 PANEL SLIDER	
OR NO	TES			

PROJECT

1112 S 5TH STREET

OWNER

AUSTIN LUXURY BUILDERS


DATE

REVISIONS

NO ISSUE

NOTES

SEAL & SIGNATURE

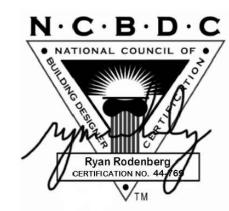

DESIGNER

—0

RODENBERG DESIGN

1702 EVERGREEN DR AUSTIN, TX 78704 512-796-5995 RYAN@RODENBERGDESIGN.COM

STRUCTURAL ENGINEER


SEC SOLUTIONS LLC MARCOS DEQUEIROGA, PE 407 FOREST STREET LIBERTY HILL, TX 78642 512-215-4364

SHEET TITLE

SCHEDULES


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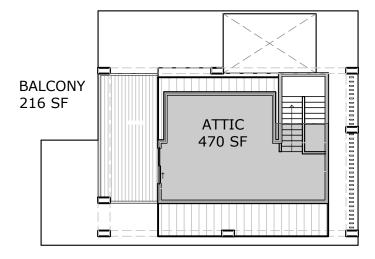
A0.2

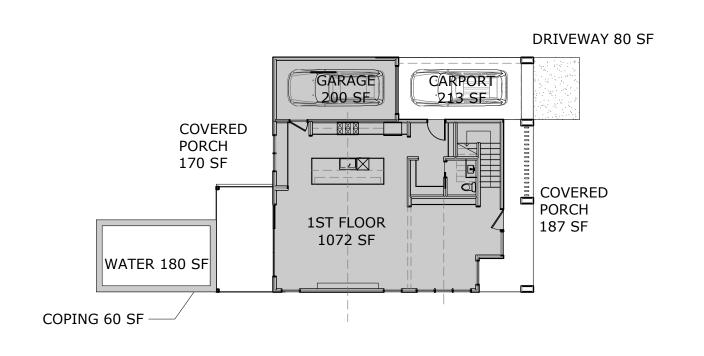


1/16" = 1'-0" @ 22x34 1/32" = 1'-0" @ 11x17

02 Area Calculations



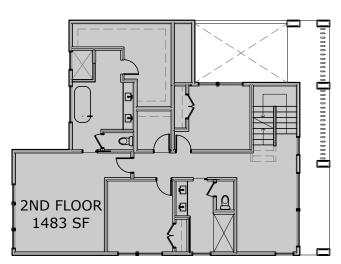

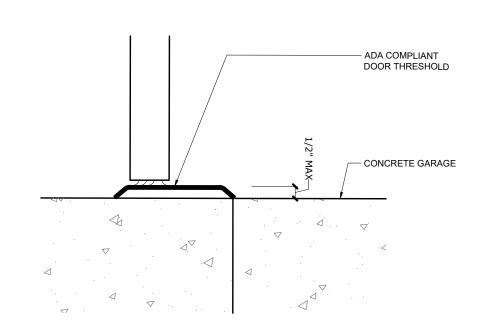

03 Threshold Detail at Entrance 3" = 1'-0" @ 22x34 1 1/2" = 1'-0" @ 11x17

Visitability Notes

- 1. Light switches and environmental controls to be installed maximum 48" above the interior floor level.
- 2. Outlets and receptacles to be installed minimum 15" above interior floor level (except for floor outlets).

Visitability Entrance

- 1. Door to be 3'-0" x 8'-0"minimum.
- 2. Landing to be $3'-0" \times 3'-0"$ minimum with maximum slope of $\frac{1}{4}$ "/ft.
- 3. If foundation plan shows more than 1 ½" drop, design professional must provide threshold detail.

Visitability Bathroom

behind lavatory).

above finish floor (except

minimum.

- 1. Door to be $3'-0" \times 8'-0"$
- 1112 S 5TH STREET 2. 2x6 blocking, centerline at 34"


OWNER


AUSTIN LUXURY BUILDERS

REVISIONS

NO ISSUE DATE

NOTES

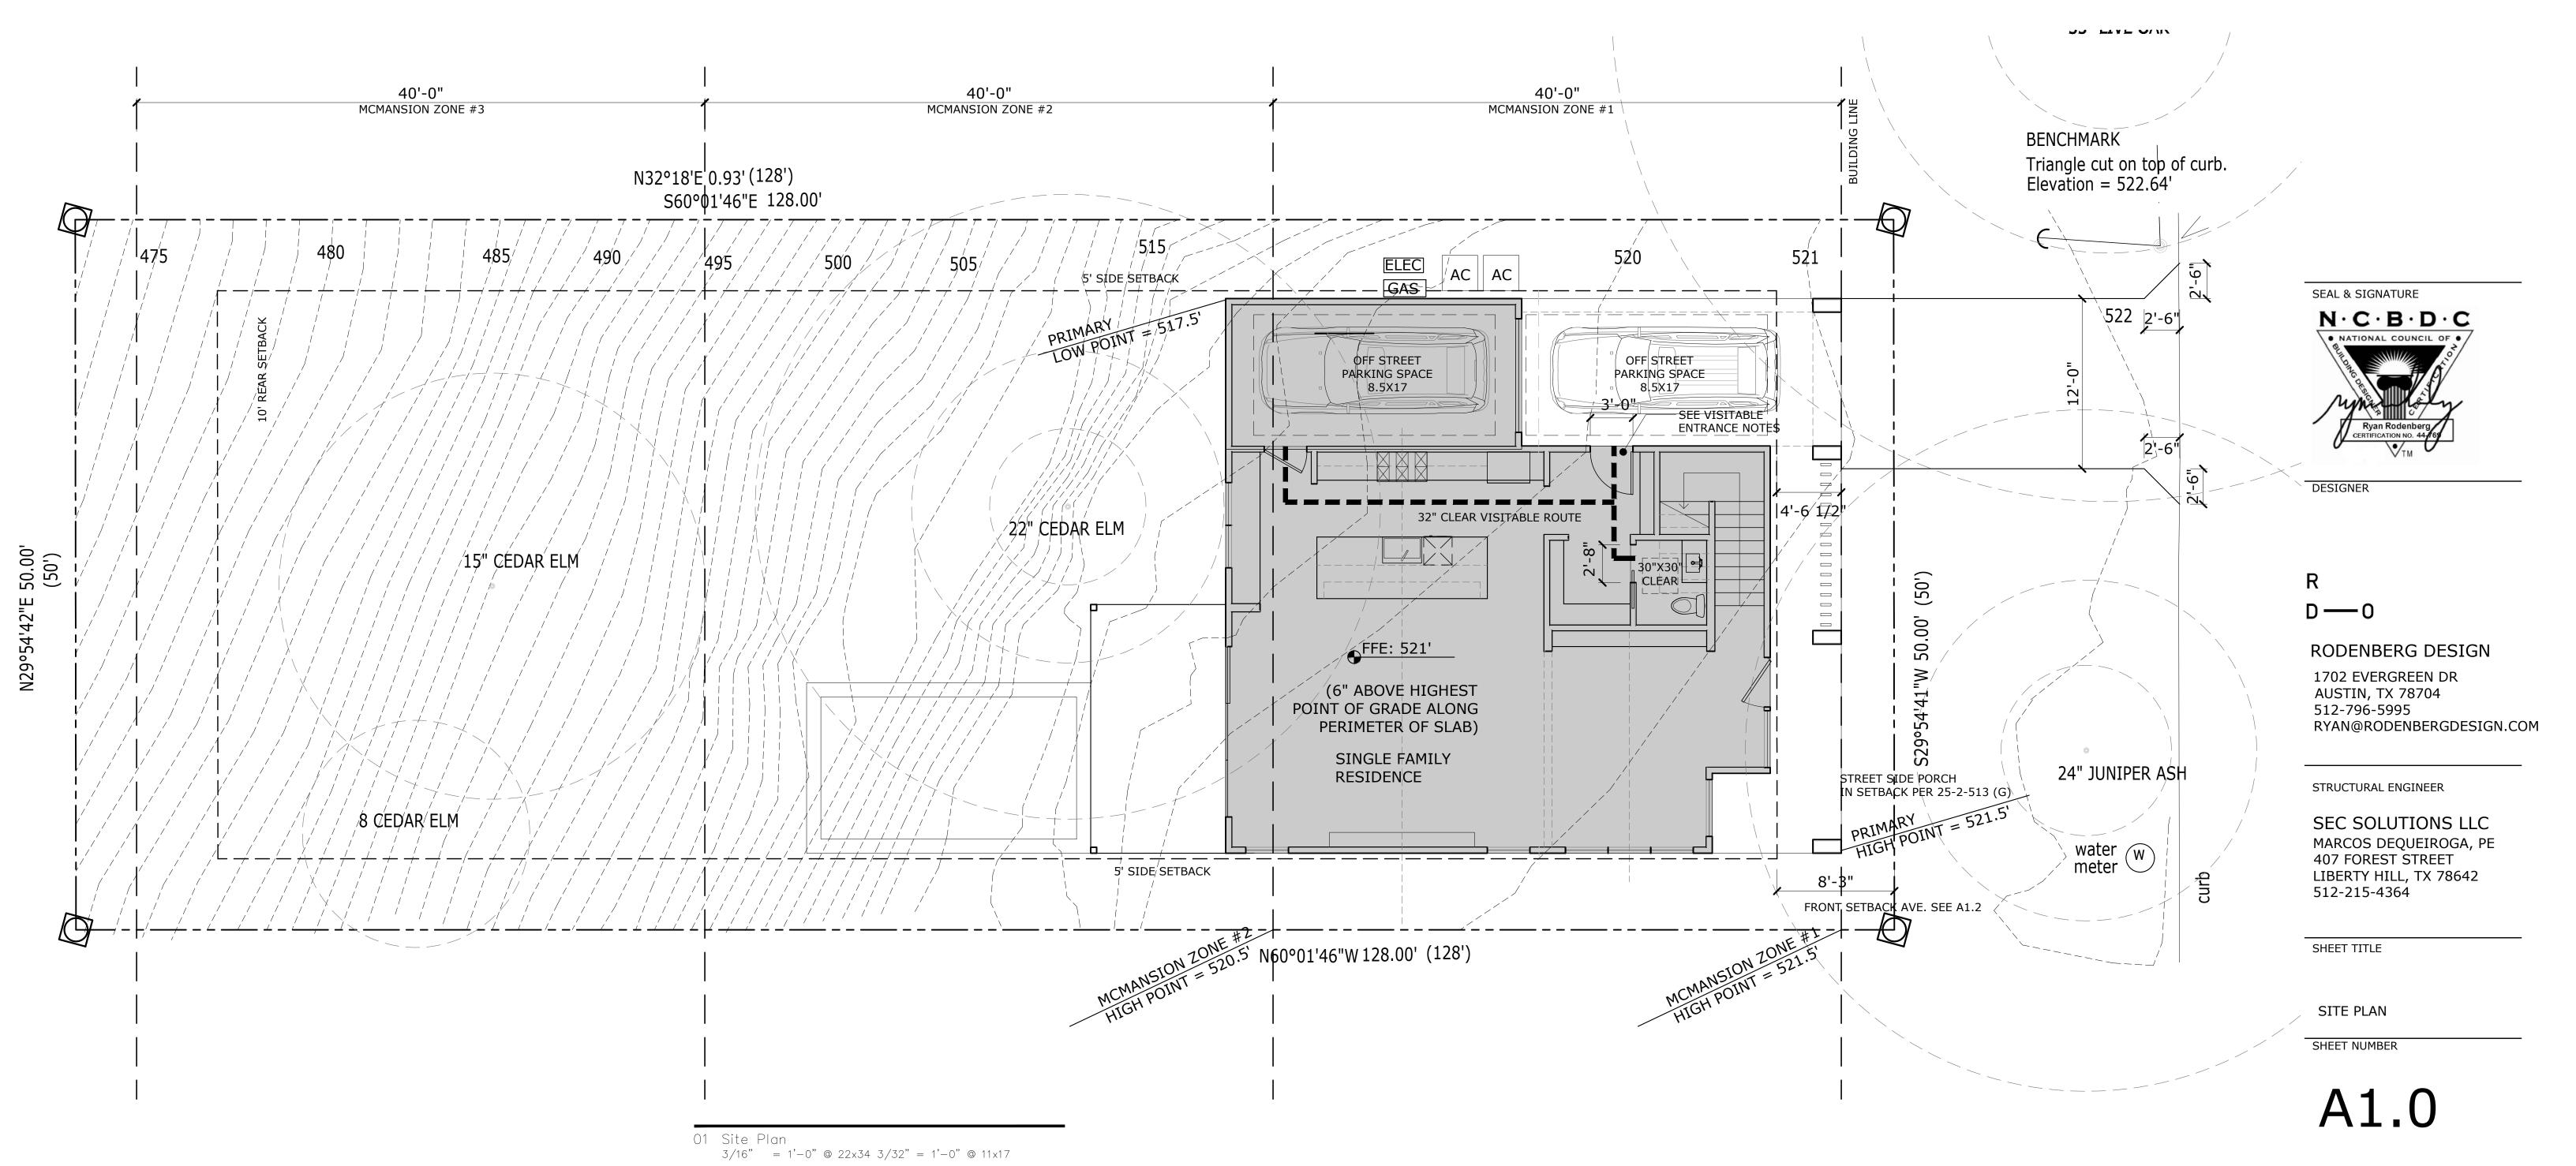

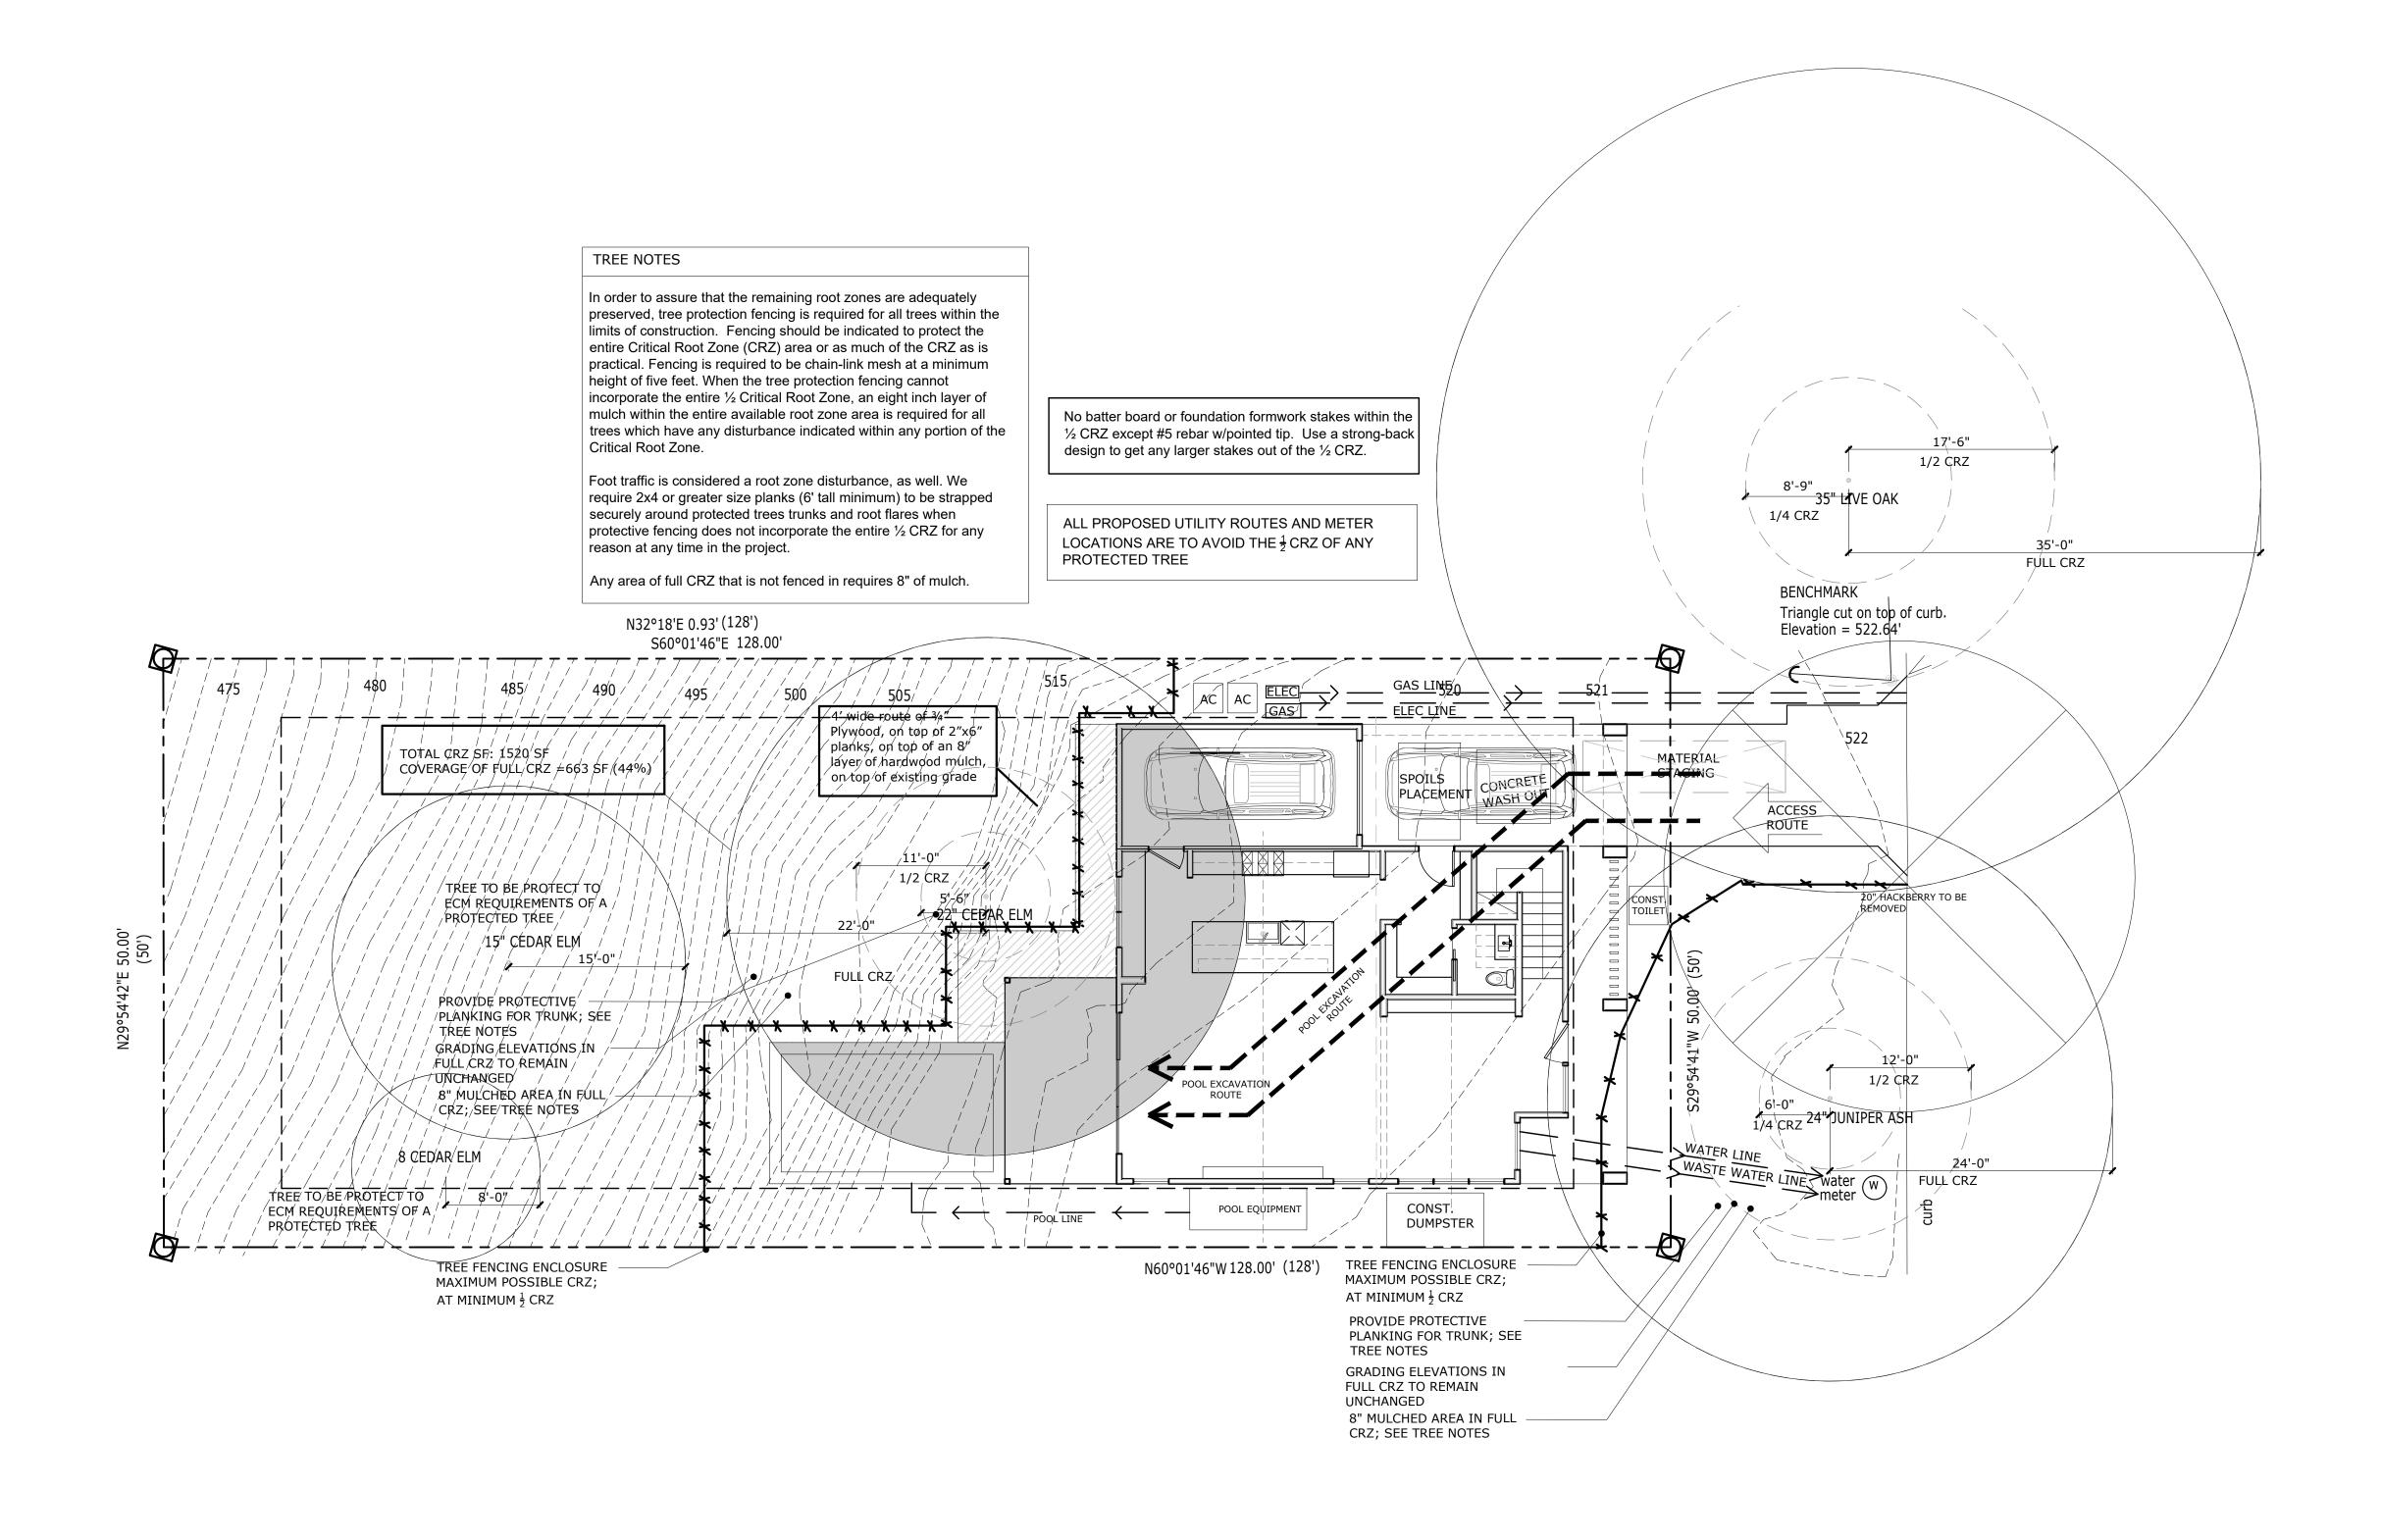

⁰¹ Tree Plan 3/16" = 1'-0" @ 22x34 3/32" = 1'-0" @ 11x17

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PROJECT

1112 S 5TH STREET

OWNER


AUSTIN LUXURY BUILDERS

REVISIONS

NO ISSUE DATE

NOTES

SEAL & SIGNATURE

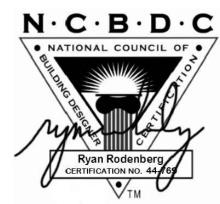

DESIGNER

R D — 0

RODENBERG DESIGN

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STRUCTURAL ENGINEER

SEC SOLUTIONS LLC MARCOS DEQUEIROGA, PE 407 FOREST STREET LIBERTY HILL, TX 78642 512-215-4364

SHEET TITLE

TREE PLAN

SHEET NUMBER

A1.1

- 1. All walls to be 2x4; plumbing walls to be 2x6; insulate exterior walls, R—19 min.
- 2. All doors to be 96" height
- 3. § gypsum board throughout4. Green board in showers and wet areas
- 5. Shoot all plates w/ 2x Ramset w/in 6" of cut


Plan Notes

- 1. All egress windows and doors to comply with 2021 IRC R310.1, R311.2, R312.2
- 2. Stairs, handrails, and guardrails to comply with 2021
- IRC R311.5.1, R311.7, R312.1

 3. First floor of new construction with any living space to comply with all visitability standards under city code section 25-12-243, R320. Visitability items are referenced on floor plans

Legend

- Smoke detector installed in accordance with IRC 2021 R314
- Carbon monoxide detector installed in accordance with IRC 2021 R315

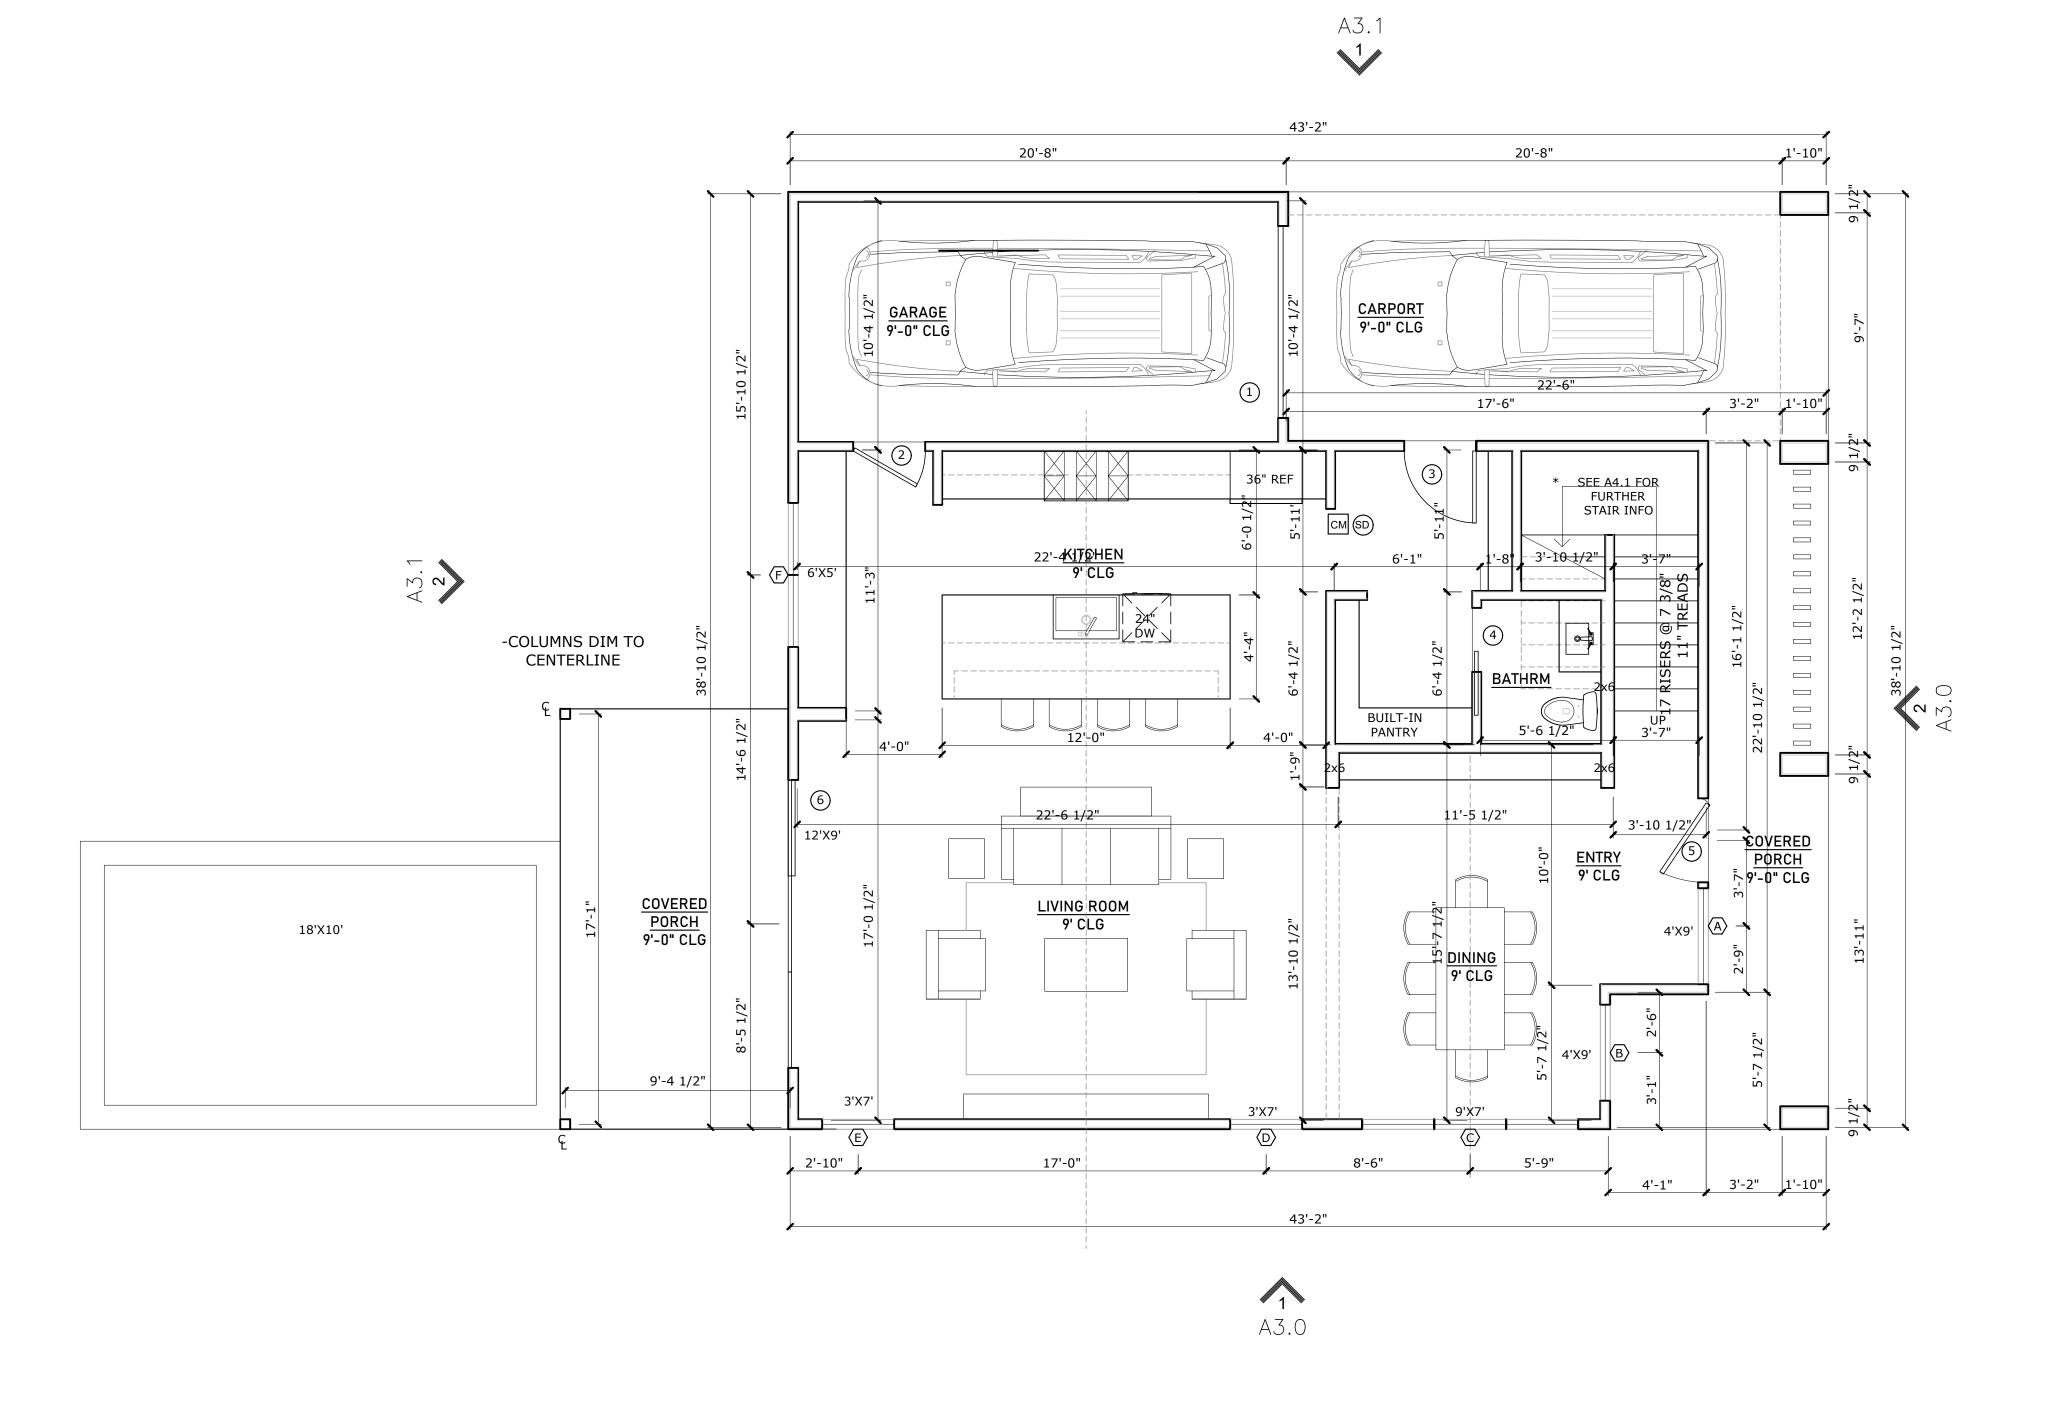

01 First Floor Plan 1/4" = 1'-0" @ 22×34 1/8" = 1'-0" @ 11×17 PROJECT

1112 S 5TH STREET

OWNER

AUSTIN LUXURY BUILDERS


DATE

REVISIONS

NO ISSUE

NOTES

SEAL & SIGNATURE

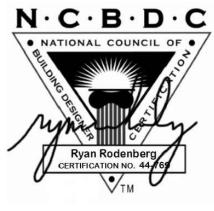

DESIGNE

R



RODENBERG DESIGN

1702 EVERGREEN DR AUSTIN, TX 78704 512-796-5995 RYAN@RODENBERGDESIGN.COM

STRUCTURAL ENGINEER

SEC SOLUTIONS LLC MARCOS DEQUEIROGA, PE 407 FOREST STREET LIBERTY HILL, TX 78642 512-215-4364

SHEET TITLE

FIRST FLOOR PLAN

SHEET NUMBER

A2.0


- 1. All walls to be 2x4; plumbing walls to be 2x6; insulate exterior walls, R—19 min.
- 2. All doors to be 96" height
- 3. § gypsum board throughout 4. Green board in showers and
- wet areas 5. Shoot all plates w/ 2x Ramset w/in 6" of cut

Plan Notes

- 1. All egress windows and doors to comply with 2021 IRC R310.1, R311.2, R312.2
- 2. Stairs, handrails, and guardrails to comply with 2021 IRC R311.5.1, R311.7, R312.1
- 3. First floor of new construction with any living space to comply with all visitability standards under city code section 25—12—243, R320. Visitability items are referenced on floor plans

Legend

- Smoke detector installed in accordance with IRC 2021 R314
- CM Carbon monoxide detector installed in accordance with IRC 2021 R315

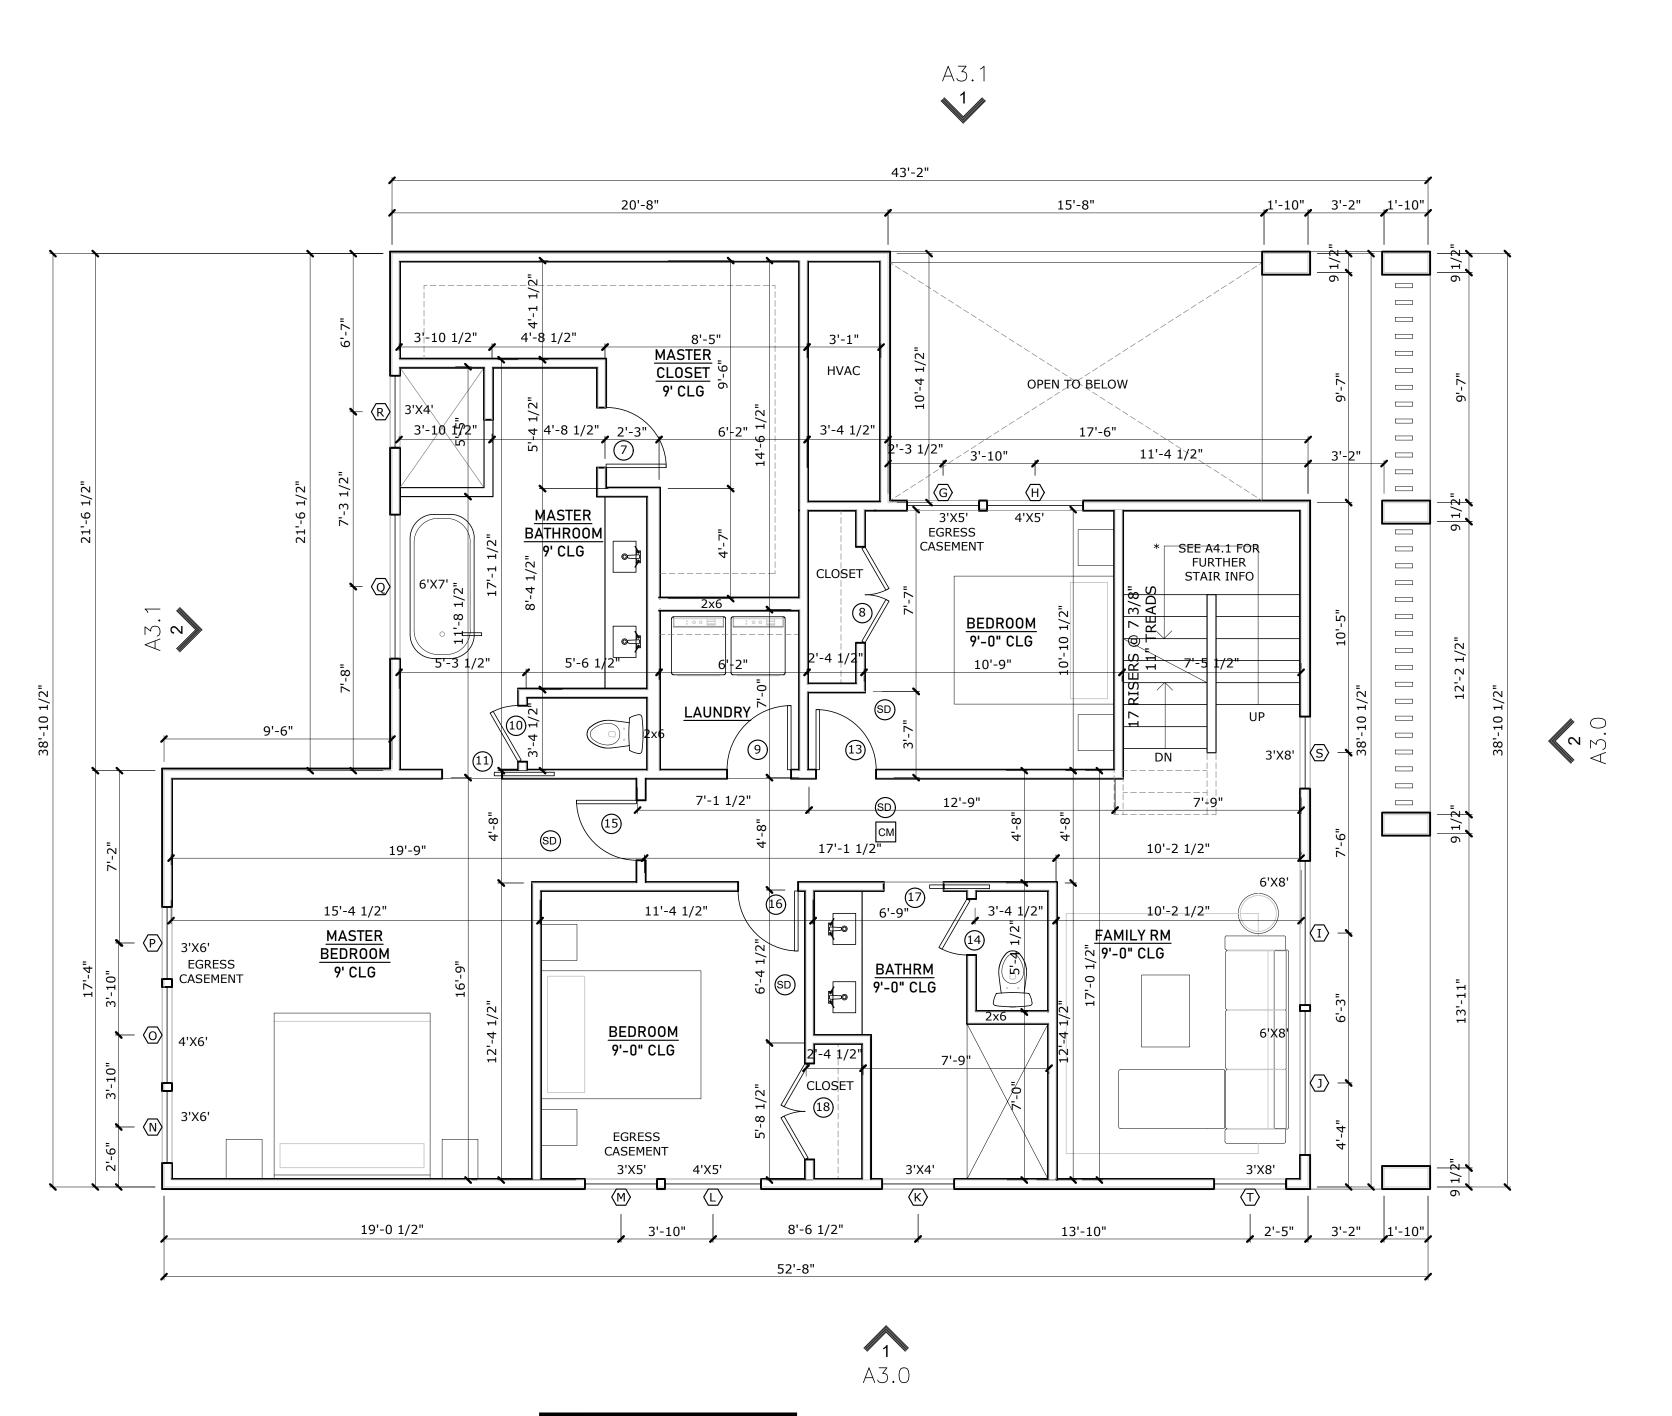

01 Second Floor Plan 1/4" = 1'-0" @ 22x34 1/8" = 1'-0" @ 11x17 PROJECT

1112 S 5TH STREET

OWNER

AUSTIN LUXURY BUILDERS

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NO ISSUE DATE

NOTES

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STRUCTURAL ENGINEER

SEC SOLUTIONS LLC MARCOS DEQUEIROGA, PE 407 FOREST STREET LIBERTY HILL, TX 78642 512-215-4364

SHEET TITLE

2ND FLOOR PLAN

SHEET NUMBER

A2.1


- 1. All walls to be 2x4; plumbing walls to be 2x6; insulate exterior walls, R-19 min.
- 2. All doors to be 96" height
- 3. § gypsum board throughout 4. Green board in showers and wet areas
- 5. Shoot all plates w/ 2x Ramset w/in 6" of cut

Plan Notes

- 1. All egress windows and doors to comply with 2021 IRC R310.1, R311.2, R312.2 2. Stairs, handrails, and
- guardrails to comply with 2021 IRC R311.5.1, R311.7, R312.1
- 3. First floor of new construction with any living space to comply with all visitability standards under city code section 25-12-243, R320. Visitability items are referenced on floor plans

Legend

- Smoke detector installed in accordance with IRC 2021 R314
- Carbon monoxide detector installed in accordance with IRC 2021 R315

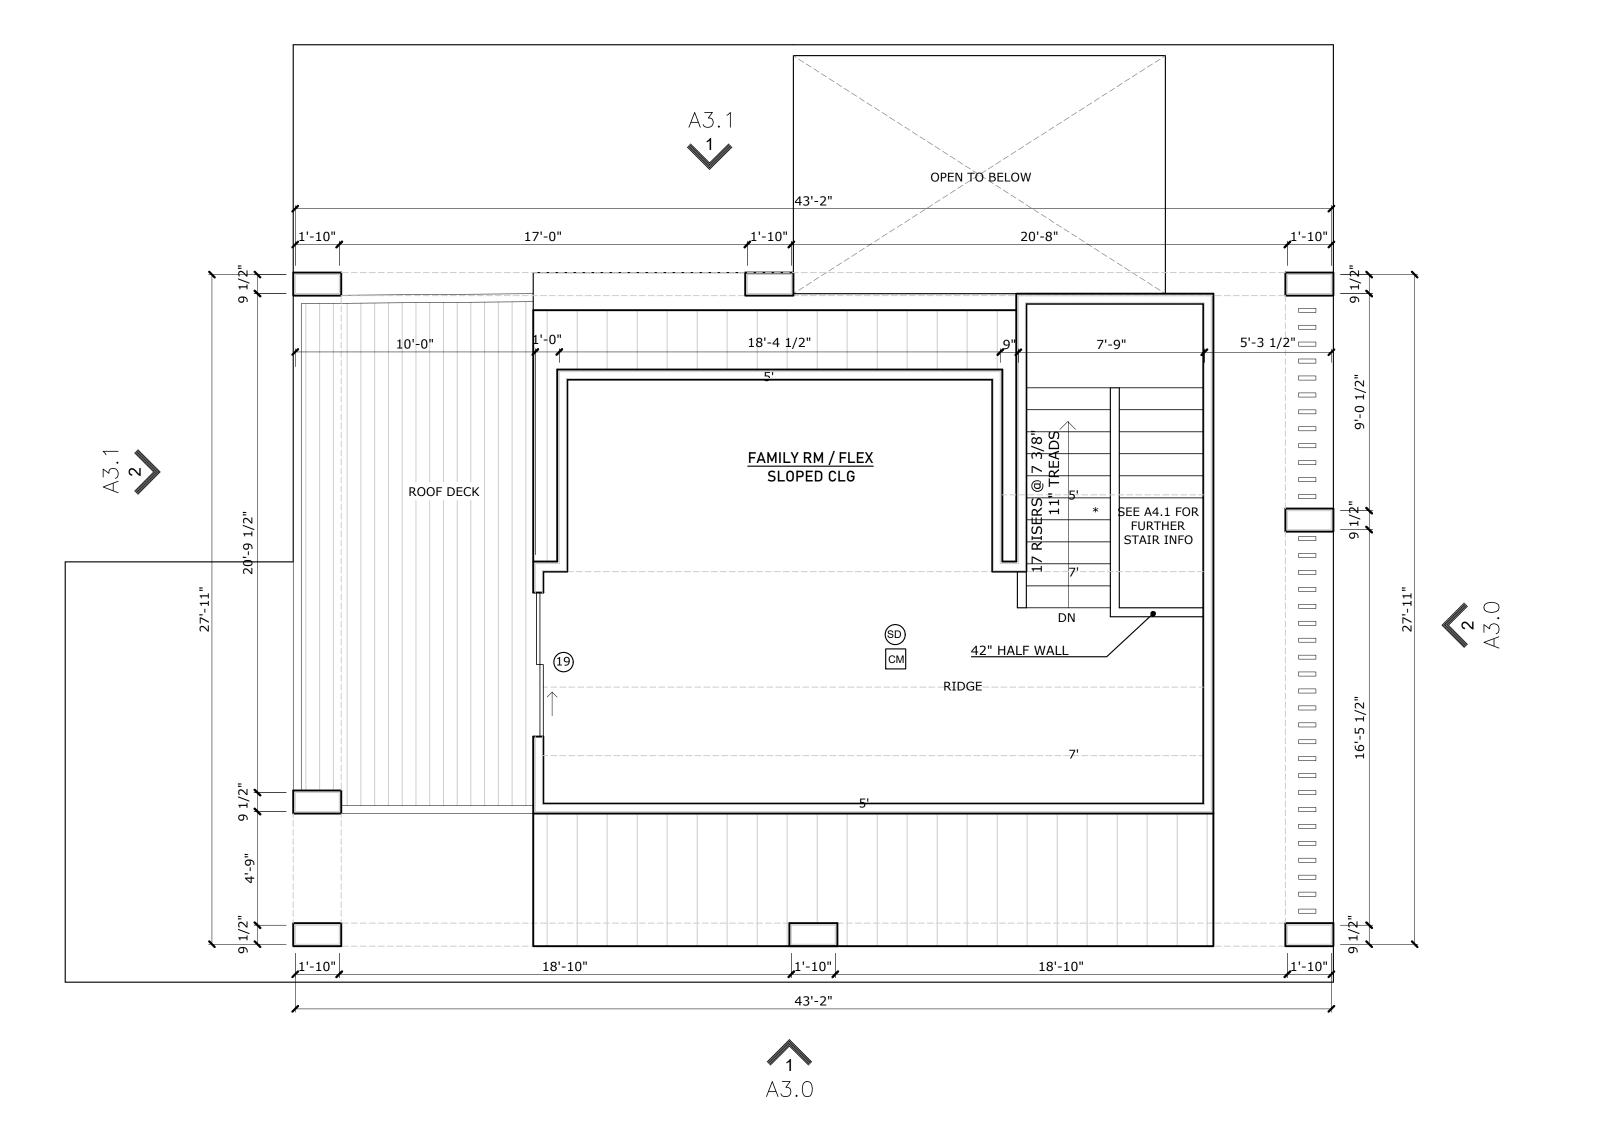

1/4" = 1'-0" @ 22x34 1/8" = 1'-0" @ 11x17

PROJECT

1112 S 5TH STREET

OWNER


AUSTIN LUXURY BUILDERS

REVISIONS

NO ISSUE DATE

NOTES

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SHEET TITLE

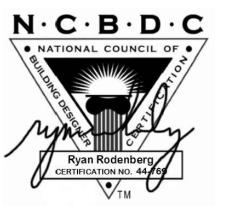ATTIC PLAN

- 1. All walls to be 2x4; plumbing walls to be 2x6; insulate
- exterior walls, R-19 min.
- 2. All doors to be 96" height
- 3. ⁵/₈" gypsum board throughout4. Green board in showers and wet areas
- 5. Shoot all plates w/ 2x Ramset w/in 6" of cut

Plan Notes


- 1. All egress windows and doors to comply with 2021 IRC R310.1, R311.2, R312.2
- 2. Stairs, handrails, and guardrails to comply with 2021 IRC R311.5.1, R311.7, R312.1
- 3. First floor of new construction with any living space to comply with all visitability standards under city code section 25-12-243, R320. Visitability items are referenced on floor plans

Legend

- Smoke detector installed in accordance with IRC 2021
- CM Carbon monoxide detector installed in accordance with IRC 2021 R315

NOTE:

ROOF DRAINAGE TO BE COORDINATED WITH ROOFING CONTRACTOR AND TO MAINTAIN A MINIMUM OF $\frac{1}{4}$ " PER LINEAR 1' IN ALL LOCATIONS.

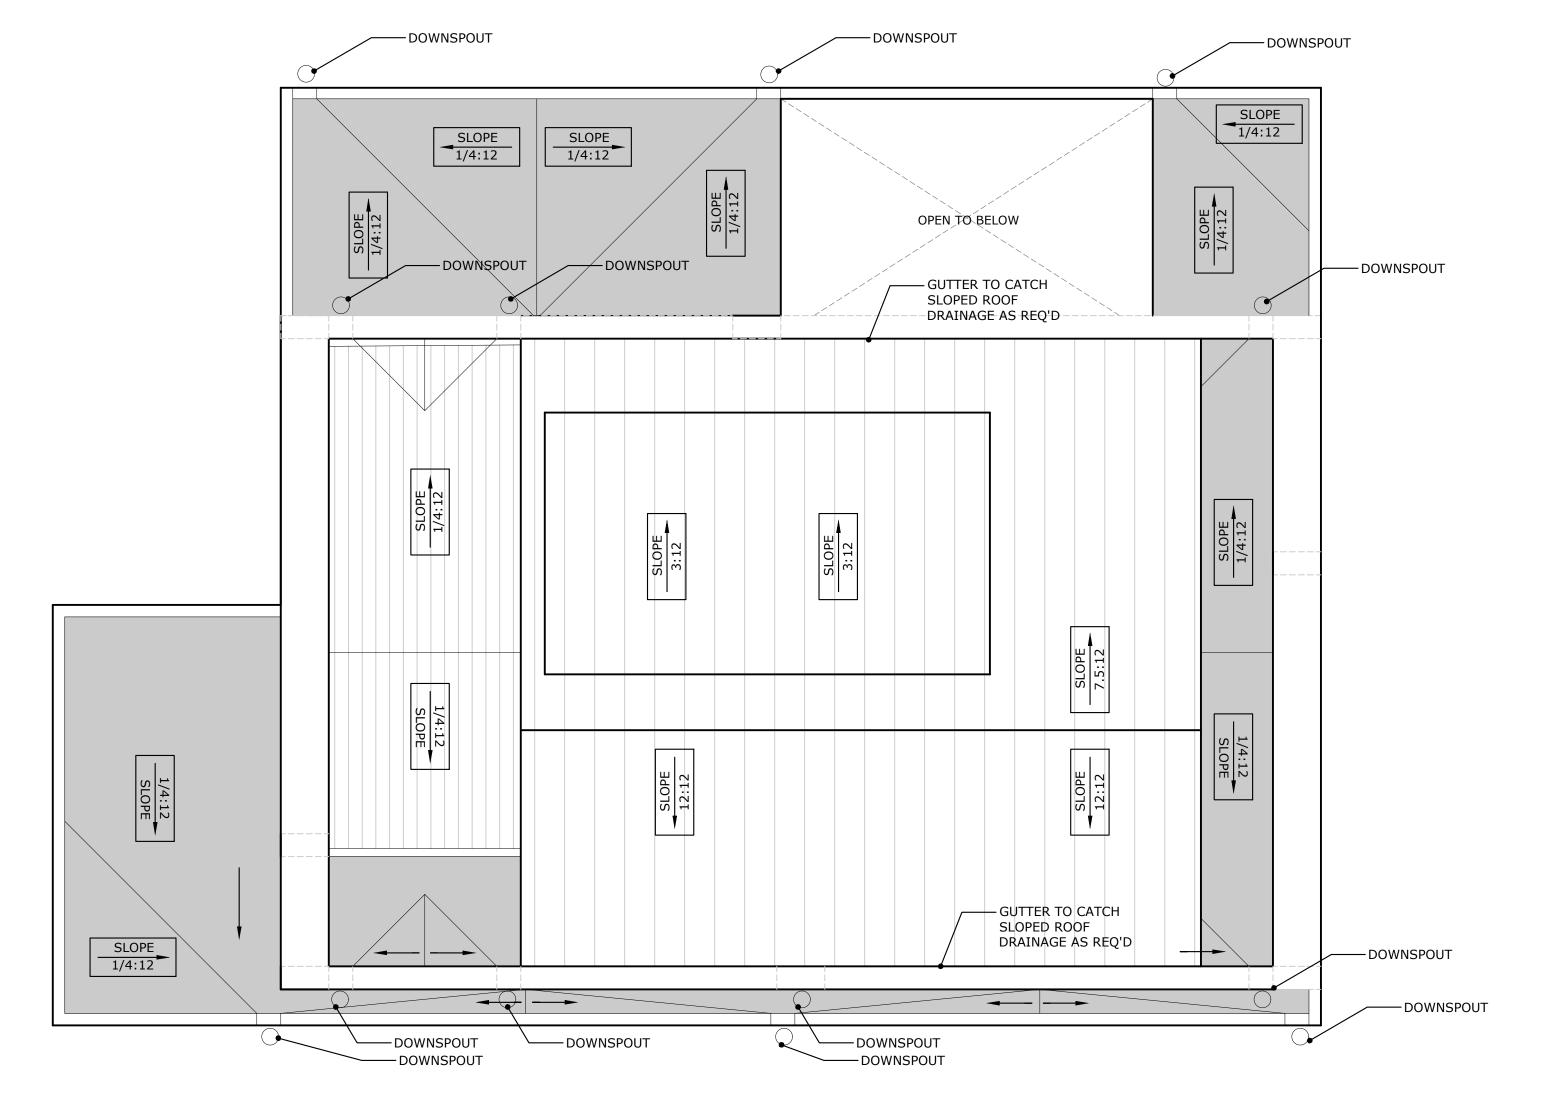

⁰¹ ROOF Plan 1/4" = 1'-0" @ 22x34 1/8" = 1'-0" @ 11x17

PROJECT

1112 S 5TH STREET

OWNER


AUSTIN LUXURY BUILDERS

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NO ISSUE DATE

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SHEET TITLE

ROOF PLAN

SHEET NUMBER

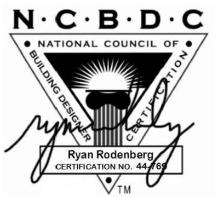42.3

NOTE:


1. PROVIDE OVERHEAD ELECTRICAL SERVICE - COORDINATE WITH GENERAL CONTRACTOR FOR LOCATION OF ELECTRICAL METER.

ELECTRICAL NOTES:


1] LAYOUT SHOWN IS SCHEMATIC ONLY. ELECTRICAL CONTRACTOR SHALL DESIGN AND FURNISH ELECTRICAL SYSTEM IN CONFORMANCE WITH ALL APPLICABLE CODES.


2] COORDINATE WITH HVAC INSTALLER TO PROVIDE POWER FOR ALL MECHANICAL UNITS.

4] PROVIDE NEW DISTRIBUTION PANELS AS REQUIRED, COORDINATE LOCATION WITH BUILDING DESIGNER.

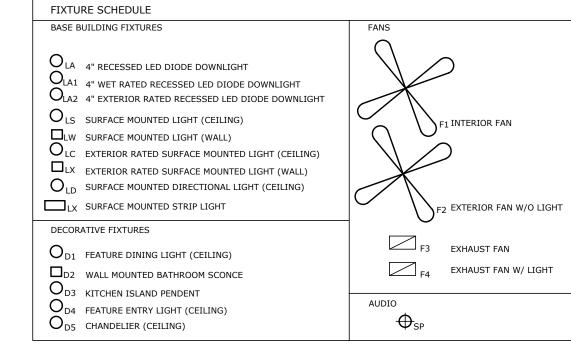

ELECTRI	ELECTRICAL LEGEND	
SYMBOL	DESCRIPTION	SD SMOKE
-0	DUPLEX OUTLET - PROVIDE GFI WHERE REQUIRED BY CODE	CARBO CARBO CM IN ACC
€ 240 V	DUPLEX OUTLET 240 V 3 PHASE	IRC 20
⊖	DUPLEX FLOOR OUTLET	HVAC
•	TELEPHONE/NETWORK/CABLE	SUPPL'
-60-	SWITCH	R RETUR
69 2	2-WAY SWITCH	
•• 0	DIMMER SWITCH	
GD	GARBAGE DISPOSAL	
↔ °	СОМВО SWITCH	
GFI	GROUND FAULT INTERUPT OUTLET	

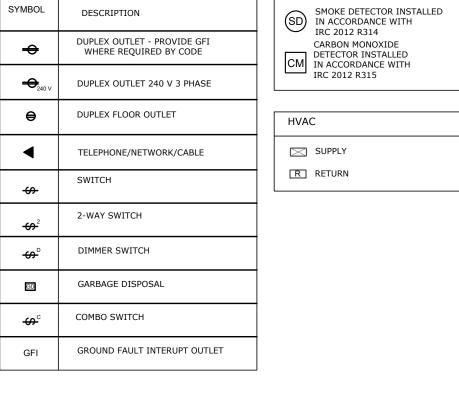

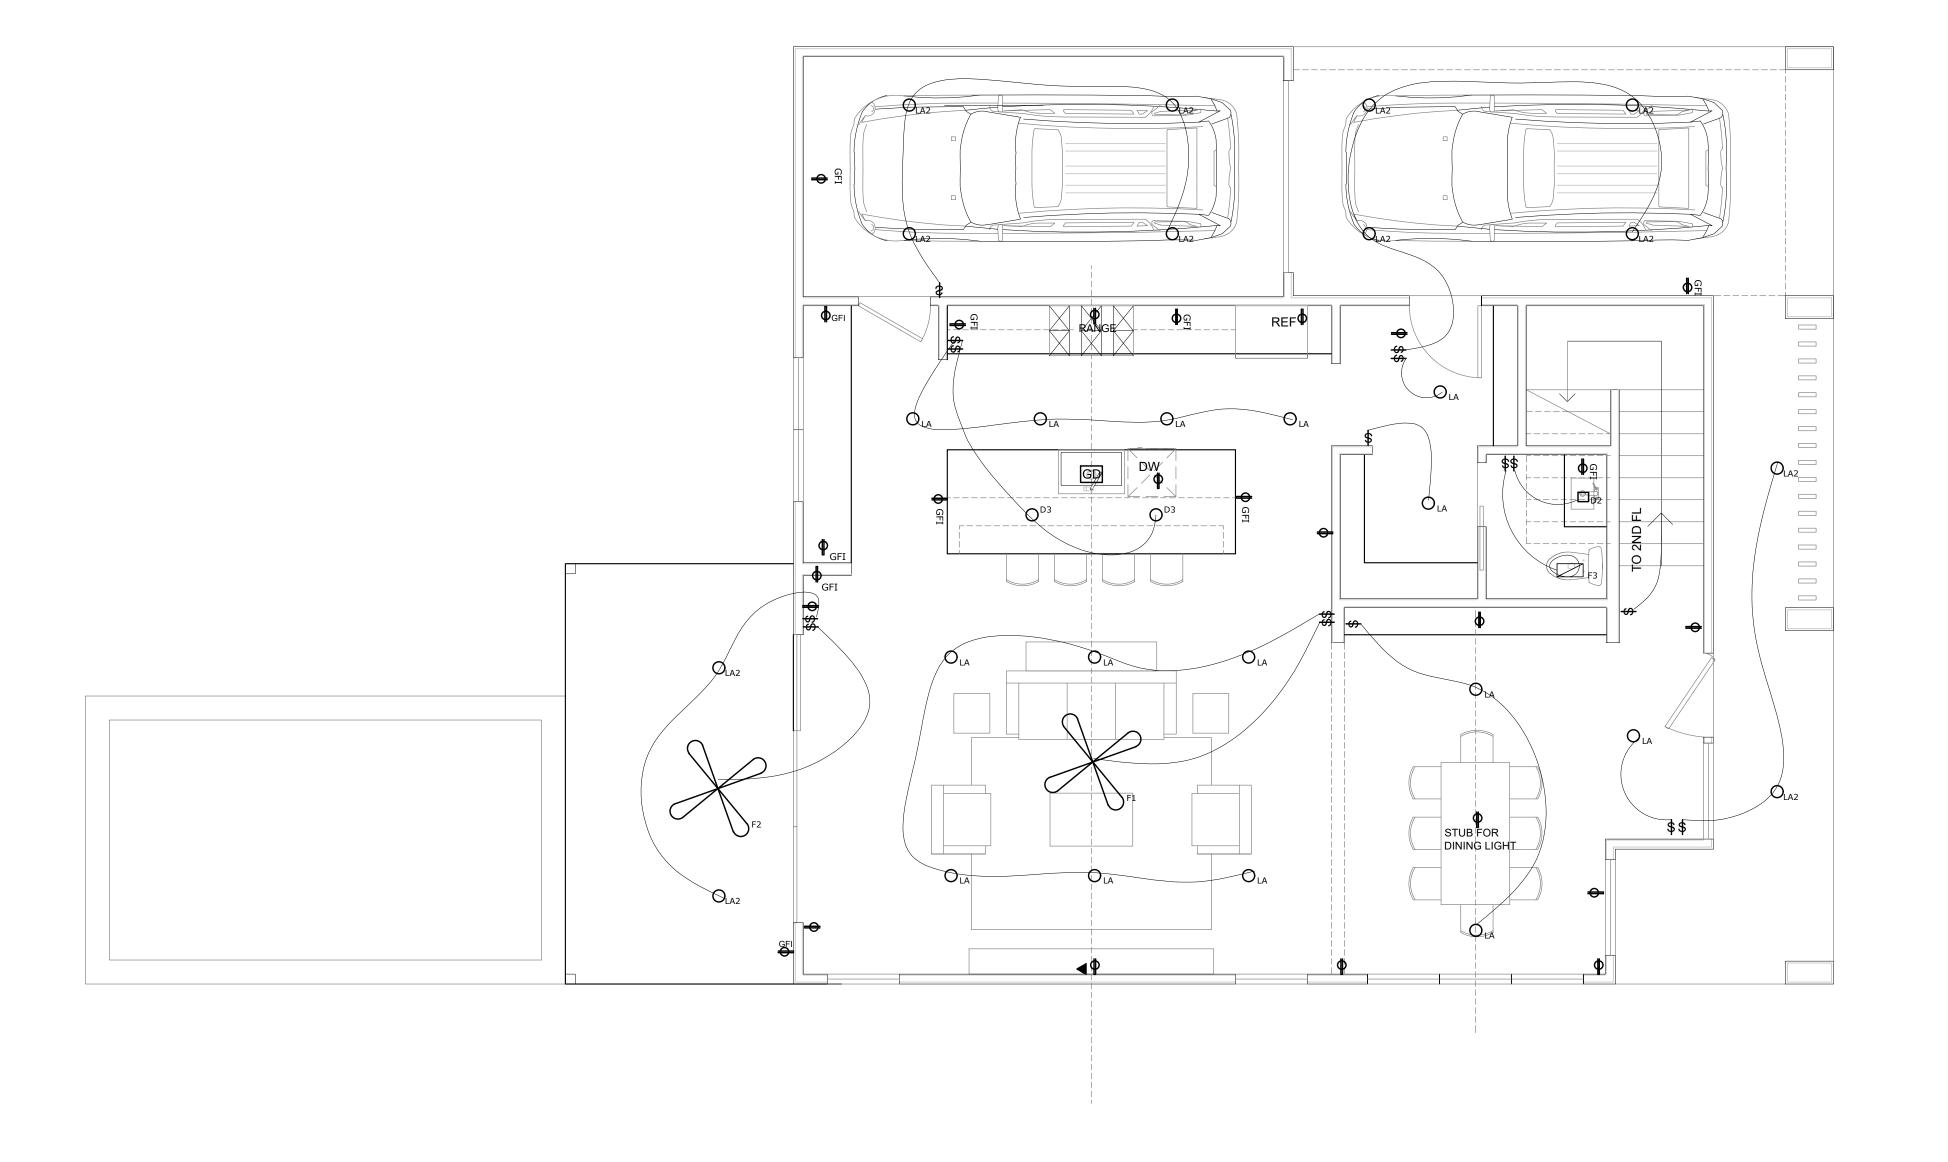

01 First Floor Electrical Plan 1/4" = 1'-0" @ 22x34 1/8" = 1'-0" @ 11x17 PROJECT

1112 S 5TH STREET

OWNER

AUSTIN LUXURY BUILDERS


DATE

REVISIONS

NO ISSUE

NOTES

SEAL & SIGNATURE

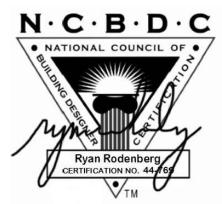

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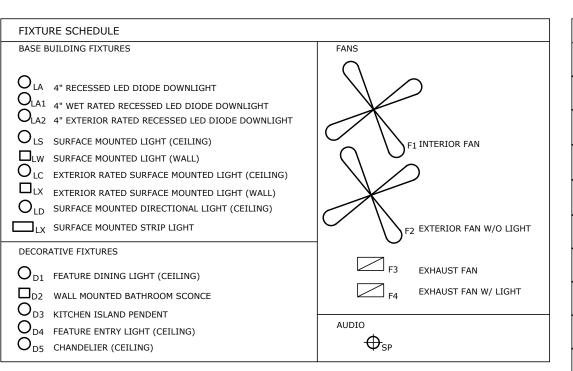
1702 EVERGREEN DR AUSTIN, TX 78704 512-796-5995 RYAN@RODENBERGDESIGN.COM

STRUCTURAL ENGINEER

SEC SOLUTIONS LLC MARCOS DEQUEIROGA, PE 407 FOREST STREET LIBERTY HILL, TX 78642 512-215-4364

SHEET TITLE

ELECTRICAL PLANS



ELECTRIC	CAL LEGEND	NOTES:		
SYMBOL	DESCRIPTION	SD SMOKE DETECTOR INSTALLED IN ACCORDANCE WITH IRC 2012 R314		
-	DUPLEX OUTLET - PROVIDE GFI WHERE REQUIRED BY CODE	CARBON MONOXIDE DETECTOR INSTALLED IN ACCORDANCE WITH		
€ 240 V	DUPLEX OUTLET 240 V 3 PHASE	IRC 2012 R315		
⊖	DUPLEX FLOOR OUTLET	HVAC		
•	TELEPHONE/NETWORK/CABLE	SUPPLY		
₩	SWITCH	R RETURN		
-69 2	2-WAY SWITCH			
♦ °	DIMMER SWITCH			
GD	GARBAGE DISPOSAL			
- ♦	сомво switch			
GFI	GROUND FAULT INTERUPT OUTLET			

NOTE:


1. PROVIDE OVERHEAD ELECTRICAL SERVICE - COORDINATE WITH GENERAL CONTRACTOR FOR LOCATION OF ELECTRICAL METER.


ELECTRICAL NOTES:

1] LAYOUT SHOWN IS SCHEMATIC ONLY. ELECTRICAL CONTRACTOR SHALL DESIGN AND FURNISH ELECTRICAL SYSTEM IN CONFORMANCE WITH ALL APPLICABLE CODES.

2] COORDINATE WITH HVAC INSTALLER TO PROVIDE POWER FOR ALL MECHANICAL UNITS.

4] PROVIDE NEW DISTRIBUTION PANELS AS REQUIRED, COORDINATE LOCATION WITH BUILDING DESIGNER.

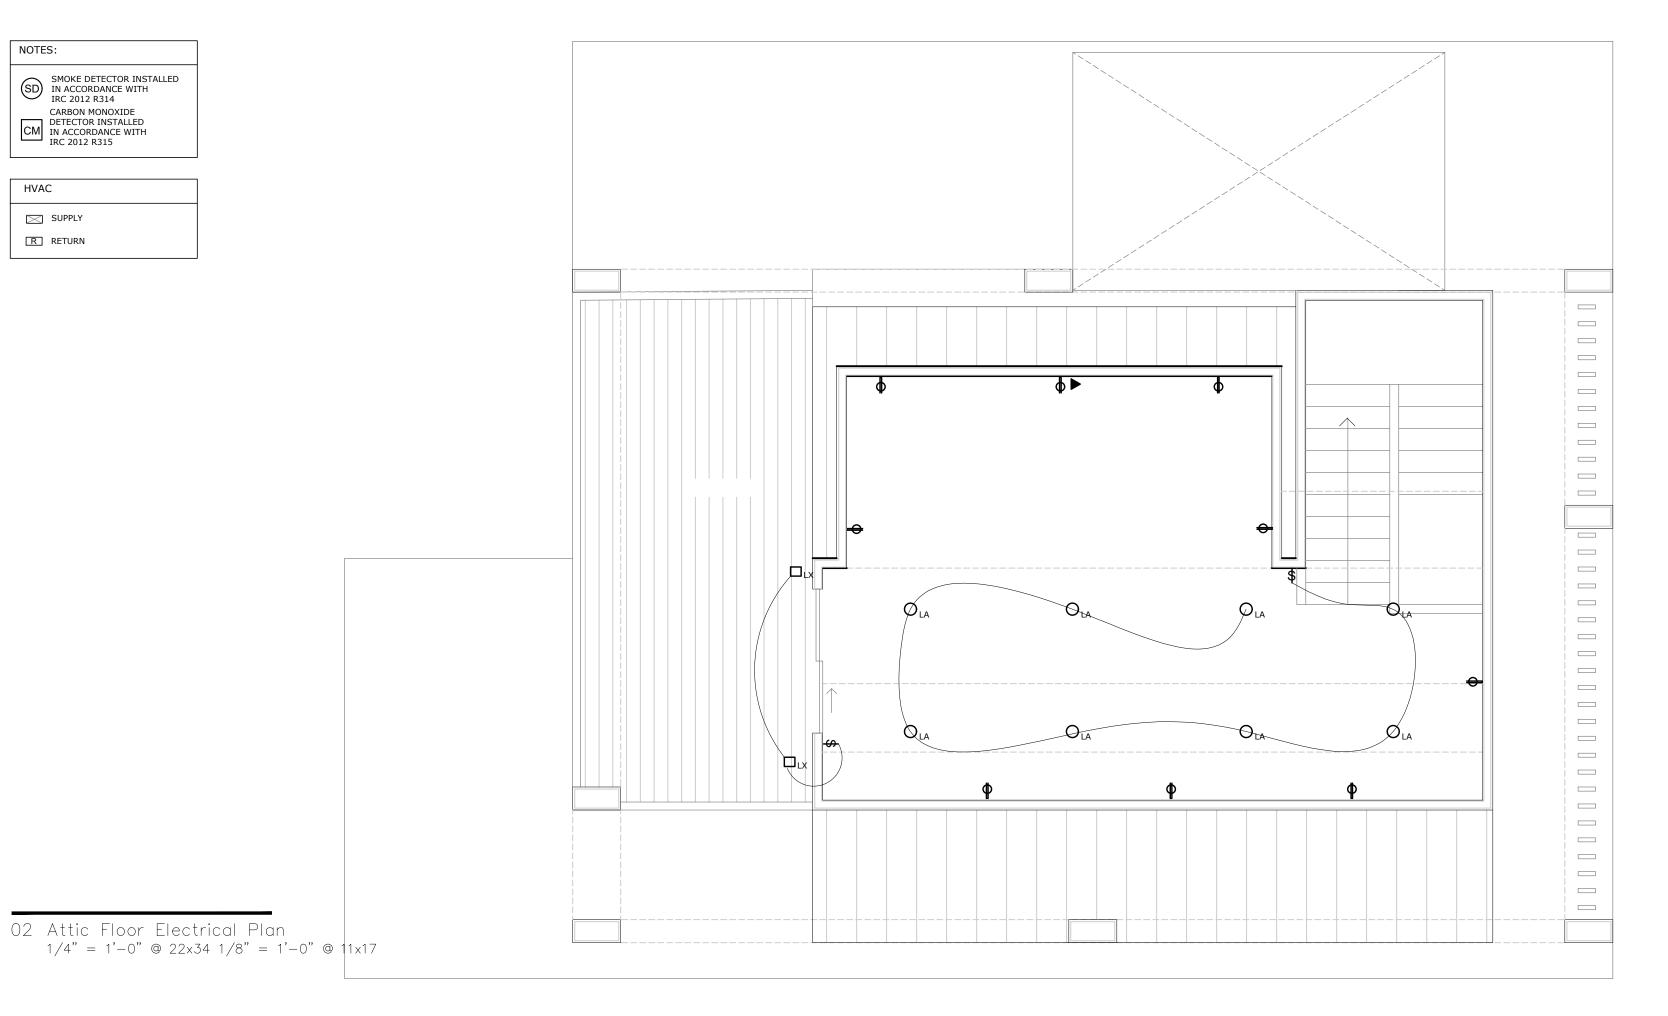

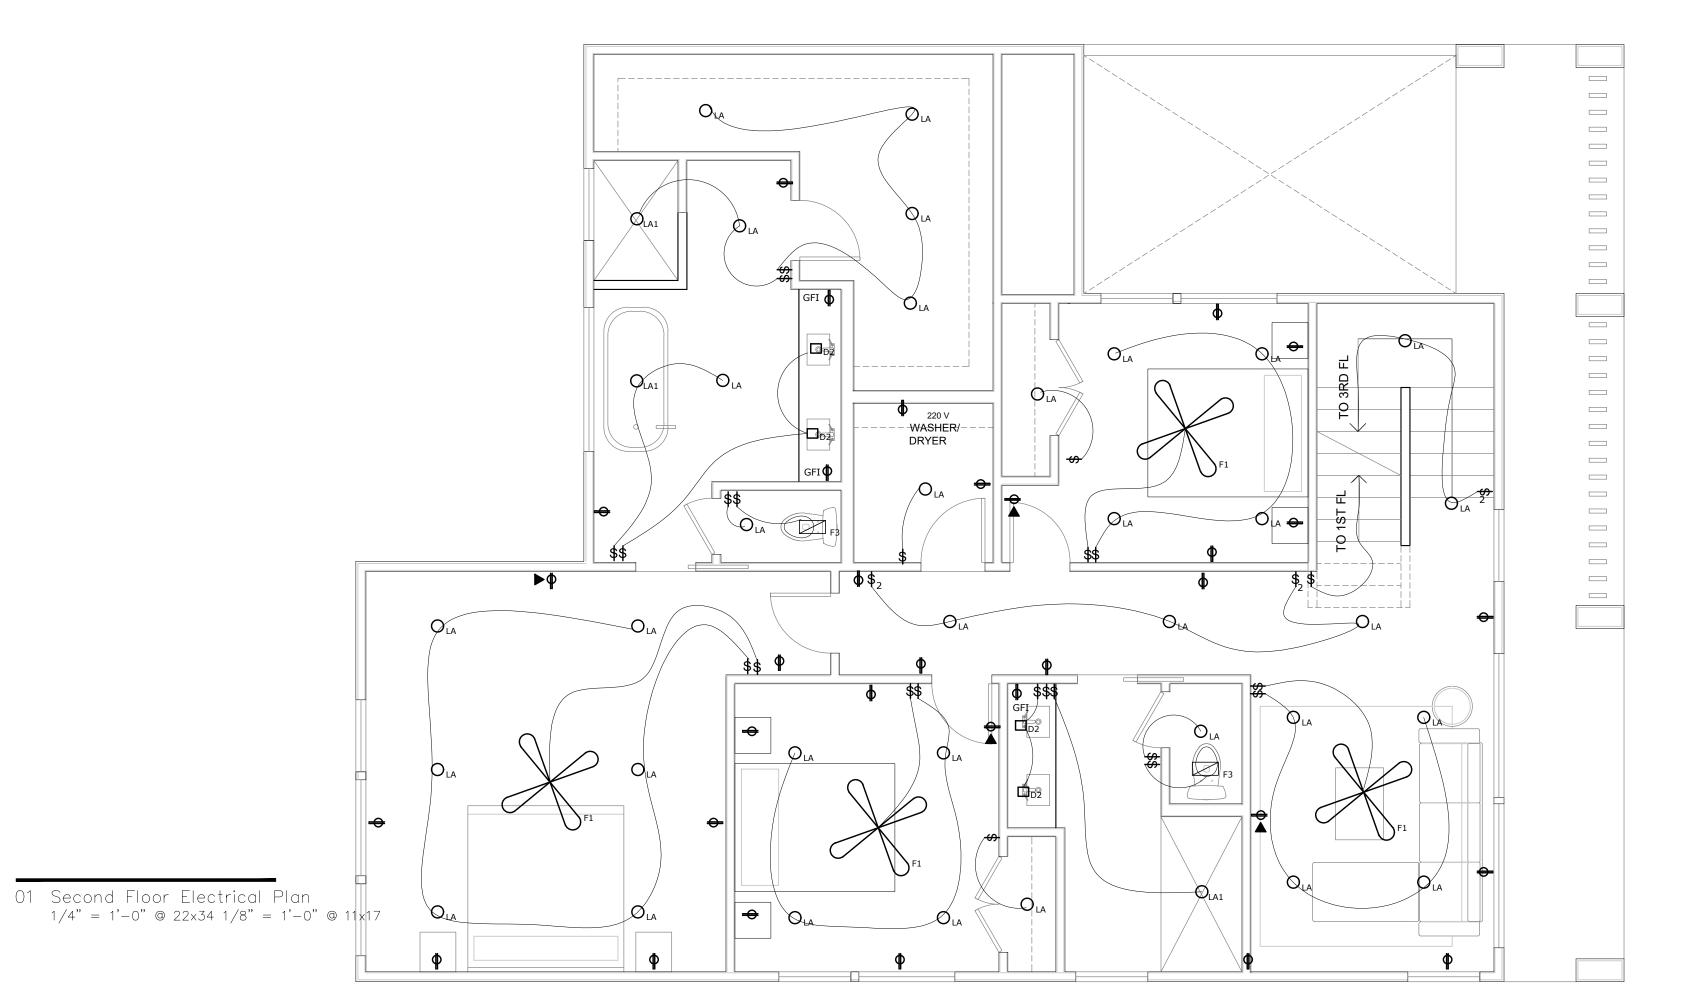

PROJECT

1112 S 5TH STREET

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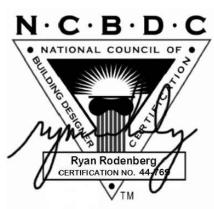
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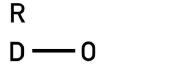
NO ISSUE

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DESTONE



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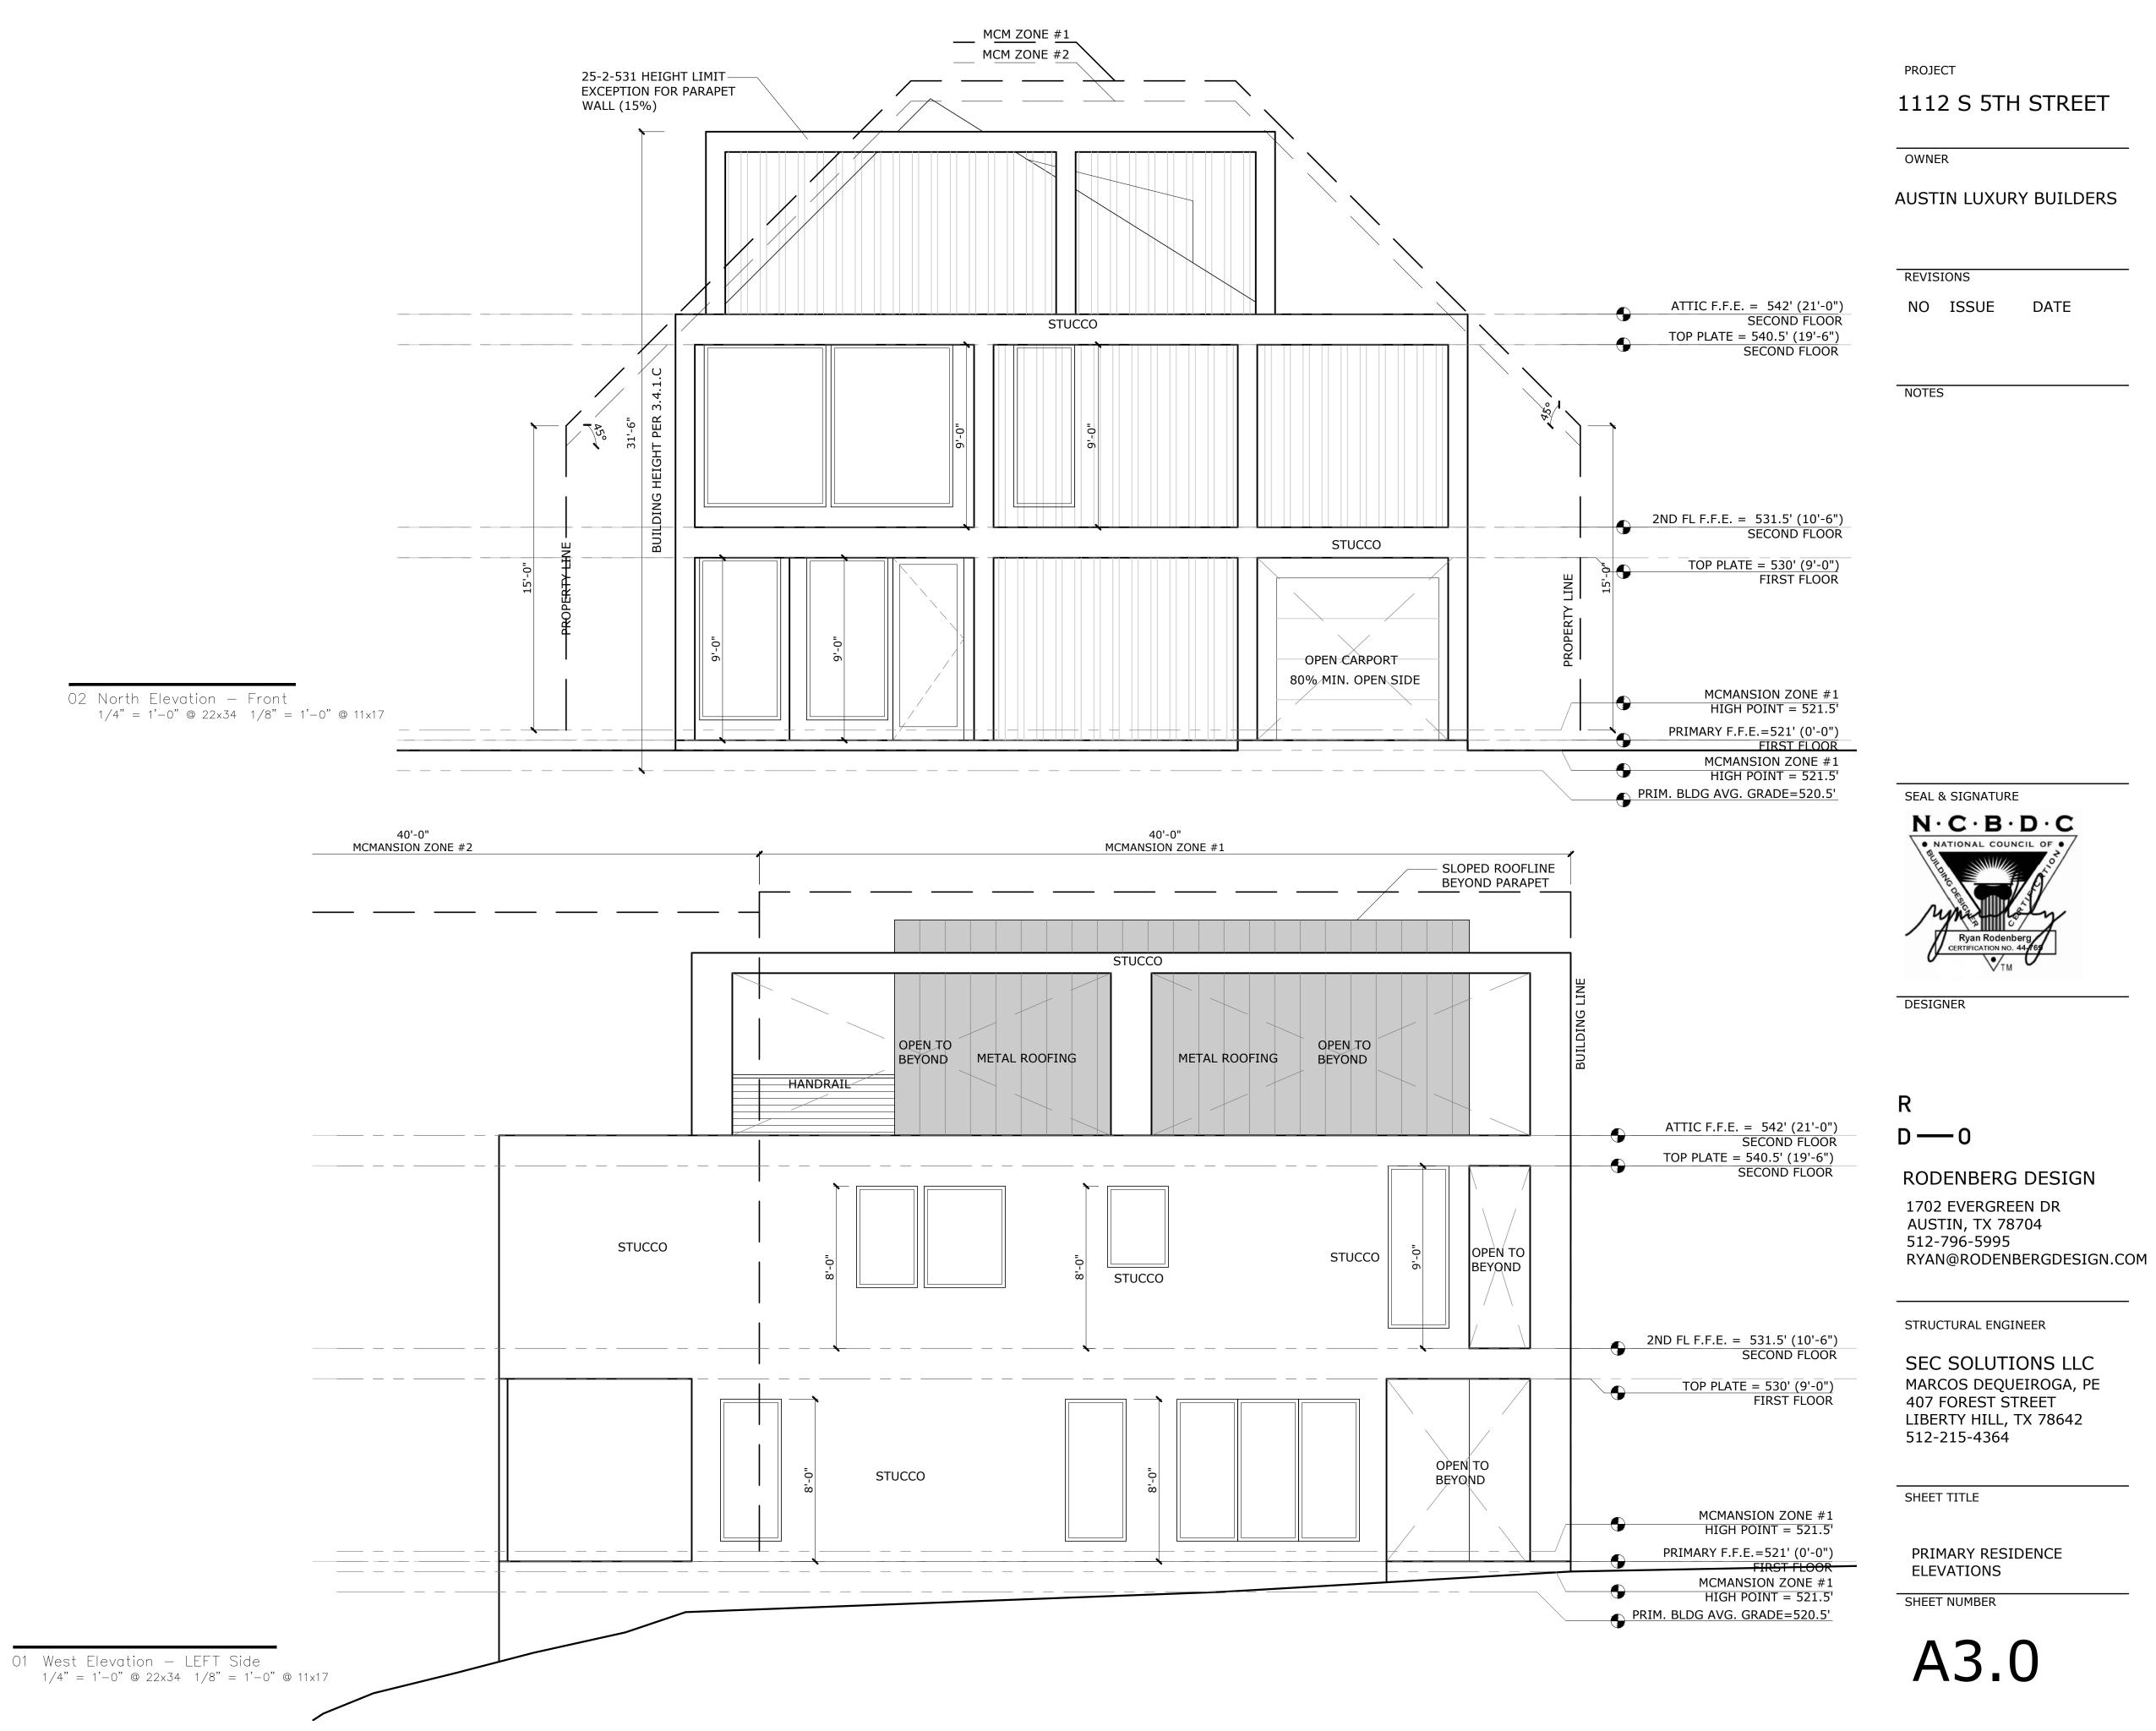
SHEET TITLE

ELECTRICAL PLANS


SHEET NUMBER


A2.5

PLEASE COORDINATE ALL WINDOWS AND DOORS WITH SCHEDULES ON A0.2



PLEASE COORDINATE ALL WINDOWS AND DOORS WITH SCHEDULES ON A0.2

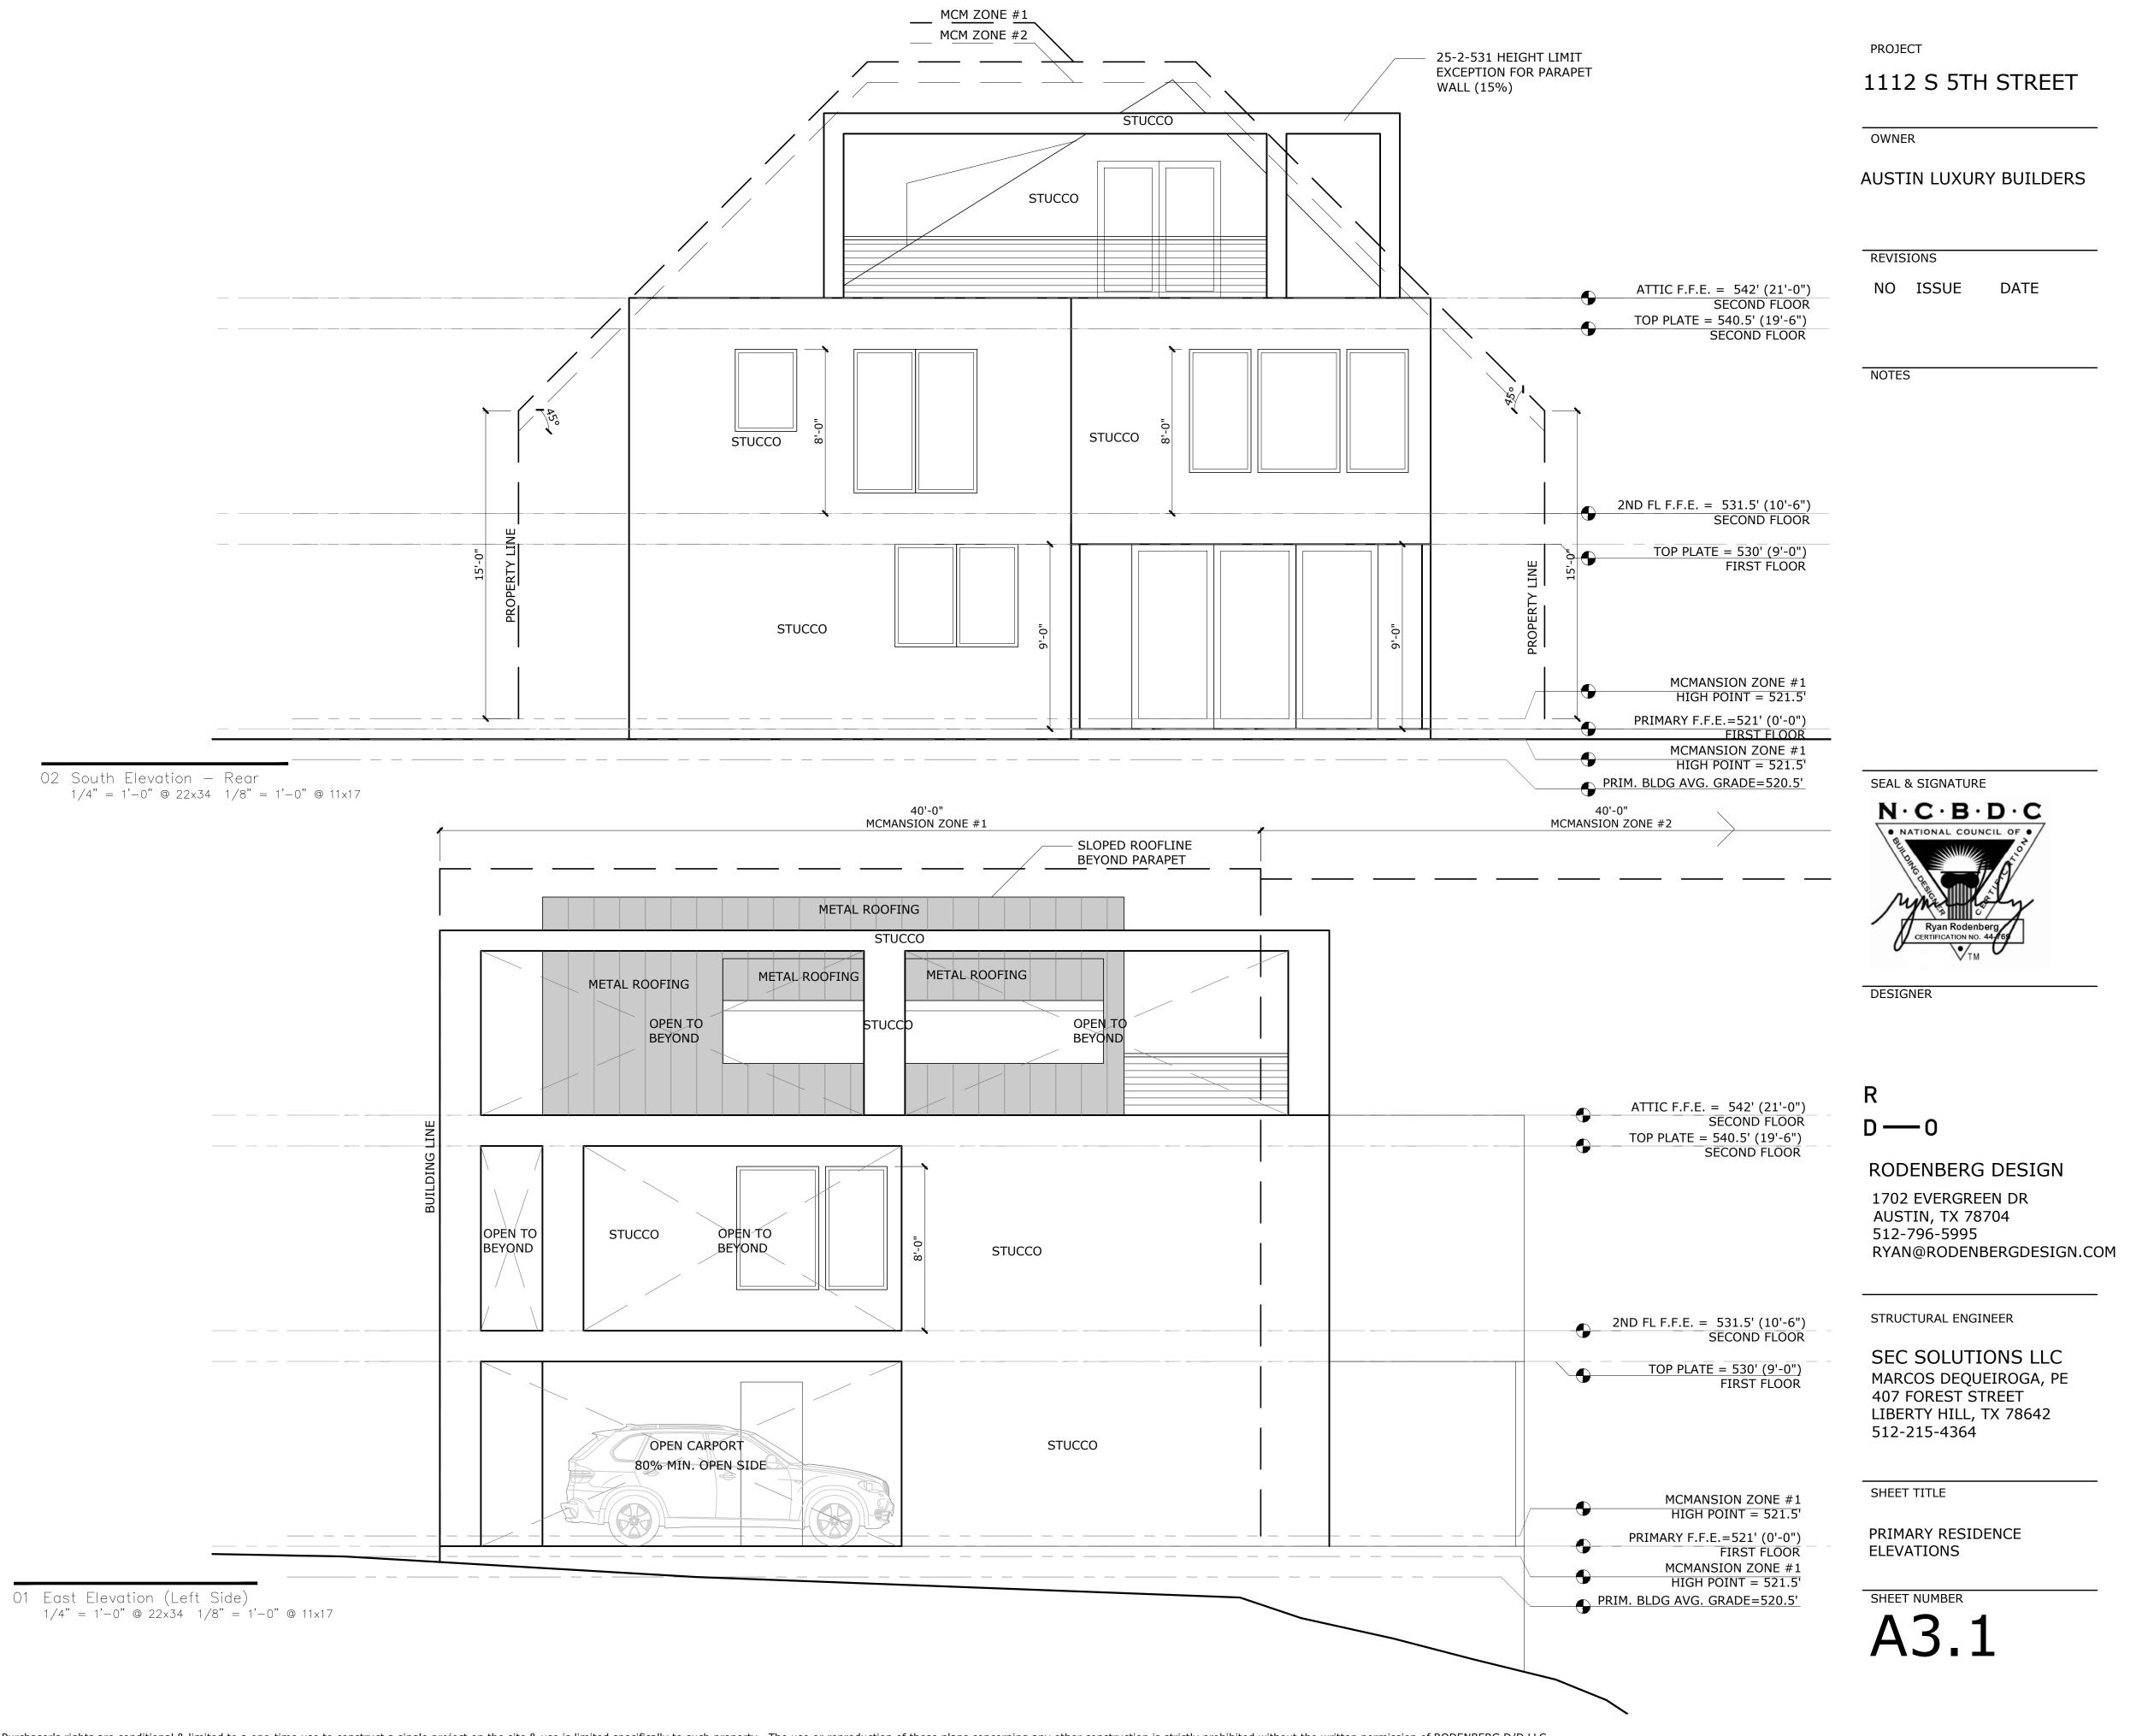

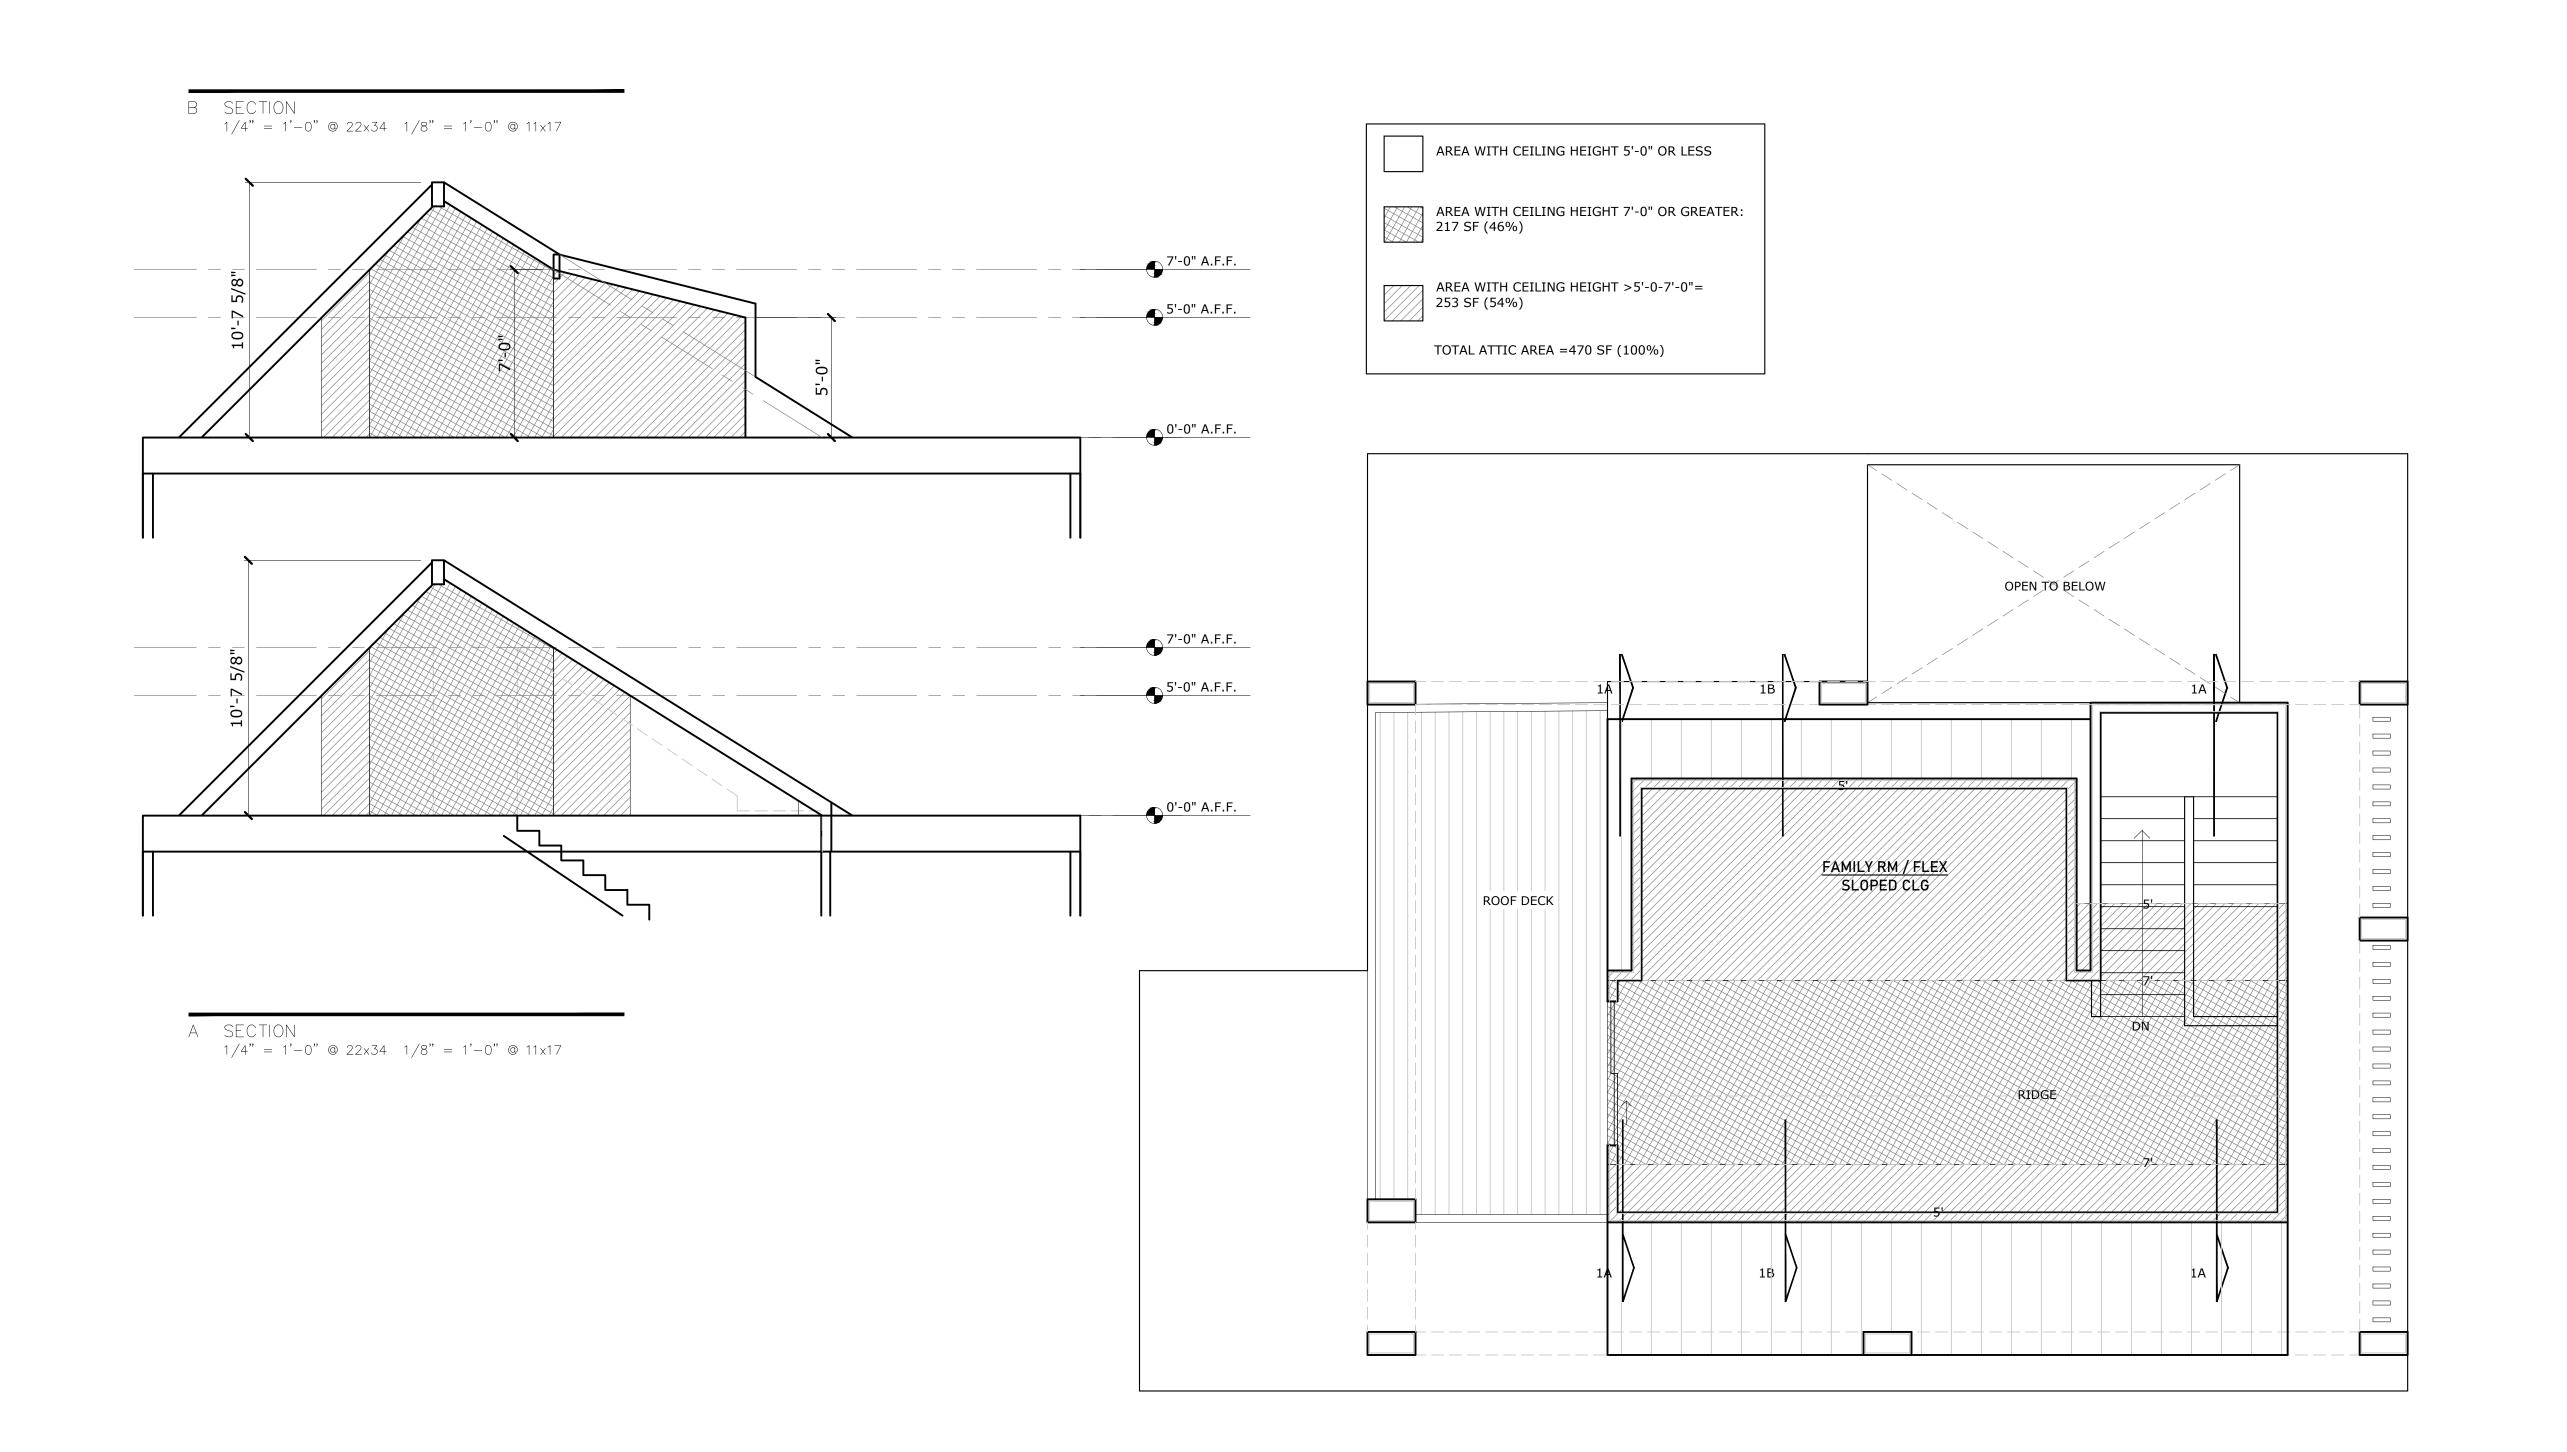

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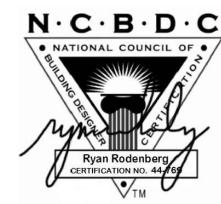
DATE

REVISIONS

NO ISSUE

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RODENBERG DESIGN


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STRUCTURAL ENGINEER

SEC SOLUTIONS LLC MARCOS DEQUEIROGA, PE 407 FOREST STREET LIBERTY HILL, TX 78642 512-215-4364

SHEET TITLE

ATTIC EXEMPTION

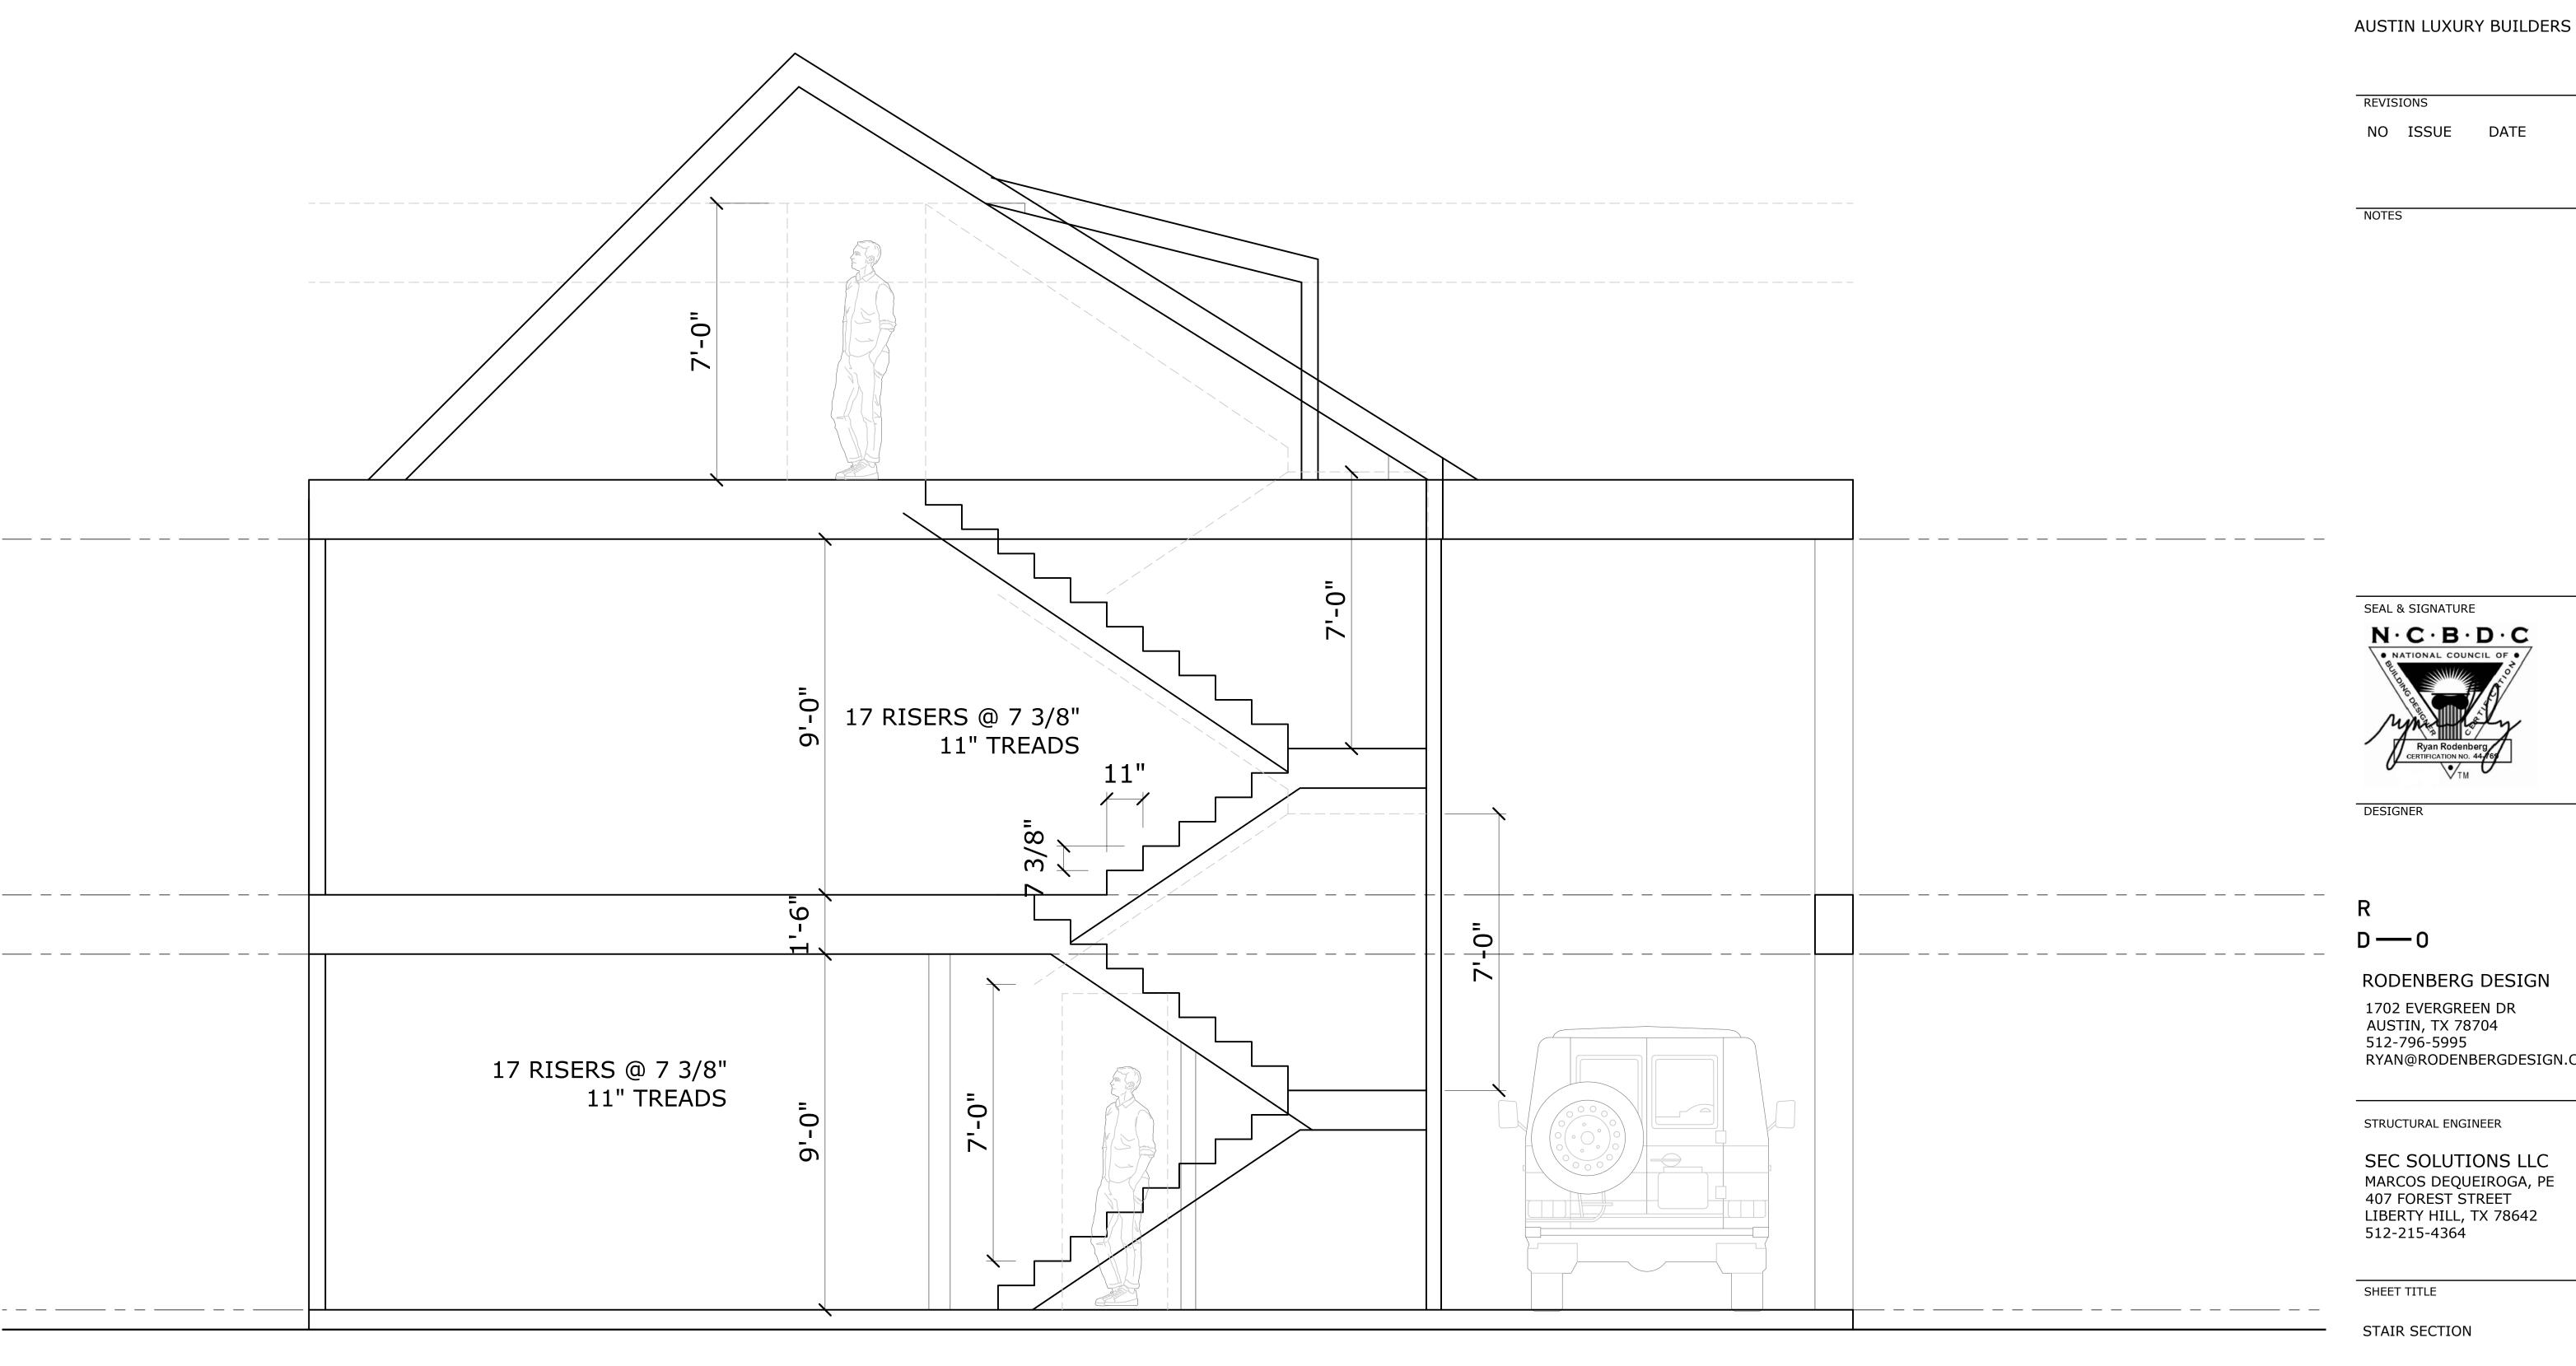

PROJECT

1112 S 5TH STREET

OWNER

RYAN@RODENBERGDESIGN.COM

SHEET NUMBER

1 SECTION 1/2" = 1'-0" @ 22x34 1/4" = 1'-0" @ 11x17