

GENERAL NOTES:

1. CONTRACTOR SHALL FIELD VERIFY AND CORRELATE ALL DIMENSIONS ON THE JOBSITE
2. FIELD VERIFY AND USE DIMENSIONS AS INDICATED. DO NOT SCALE DIMENSIONS FROM THE DRAWINGS.
3. CONTRACTOR TO LOCATE AND LAY-OUT ALL WALLS AND PARTITIONS AS THEY RELATE TO THE STRUCTURE AND OTHER BUILDING ELEMENTS AS SHOWN ON THE DRAWINGS, AND IN CONFORMANCE WITH THE DESIGN CONCEPT AND INTENT.
4. ALL FLOOR PLAN DIMENSIONS ARE TO THE FACE OF THE WOOD FRAME OR INTERIOR PARTITIONS OR FURRING ASSEMBLIES, GRID LINES OR THE CENTER LINE OF COLUMNS AND BEAMS; THE FACE OF MASONRY WALLS OR VENEERS; THE FACE OF WINDOWS FRAMES OR HOLLOW METAL DOOR FRAMES; THE EXPOSED FACE OF WOOD DOOR FRAMES (JAMB5) AT NOMINAL DOOR OPENINGS; UNLESS NOTED OTHERWISE, (U.N.O).
5. FLOOR PLAN DIMENSIONS AT EXTERIOR PERIMETER WALLS ARE TO THE FACE OF THE FRAMING AND AND DO NOT INCLUDE THE THICKNESSES OF THE EXTERIOR FINISH MATERIALS; FIBER CEMENT OR WOOD SIDING AND TRIM; STUCCO OR CEMENT PLASTER, AND/OR METAL WALL PANELS AND TRIM, OR OTHER MATERIALS AS INDICATED OR NOTED. FLOOR PLAN DIMENSIONS AT EXTERIOR PERIMETER CAVITY WALLS WITH MASONRY OR STONE VENEERS ARE TO THE FACE OF THE MASONRY OR STONE VENEERS AND THE EDGE OF THE CONCRETE SLAB FOUNDATION, UNLESS NOTED OR INDICATED OTHERWISE.
6. DIMENSIONS NOTED AS CLR. (CLEAR) AND O.T.O. (OUTSIDE TO OUTSIDE) ARE TO FINISH WALL OR PARTITIONS SURFACES.
7. PROVIDE CONCEALED WOOD BLOCKING, WOOD SUPPORT FRAMEWORK AND BRACING, AND ALL MISC. WOOD NAILERS, ETC., AS REQUIRED.

8. PROVIDE CONCEALED WOOD BLOCKING, CONTINUOUS, WHERE REQUIRED IN ALL WOOD STUD PARTITIONS FOR THE PROPER ANCHORAGE OF WALL ATTACHED ITEMS, SUCH AS MIRRORS, TOILET ACCESSORIES, FUTURE GRAB BARS, WALL-HUNG AND BASE CABINETS, COUNTERTOPS, WALL-HUNG LAVATORIES, CLOSET RODS, CLOSET LEDGER STRIPS AND SHELVES, METALS SHELF BRACKETS, OWNER PROVIDED CLOSET SYSTEM ITEMS, FIRE EXTINGUISHERS, BRACING AT CEILING FANS, AND ALL OTHER ITEMS OR MISCELLANEOUS EQUIPMENT.

9. ALL INTERIOR PARTITION WALLS EXTEND TO THE BOTTOM OF THE CEILING/ FLOOR FRAMING OR ROOF FRAMING, UNLESS NOTED OTHERWISE, AND BRACED TO THE STRUCTURE AS REQUIRES TO PREVENT MOVEMENT OR DEFLECTION.

10. ALL INTERIOR PARTITION WALLS EXTEND TO THE STRUCTURE OR THE BOTTOM OF CEILING/FLOOR FRAMING OR CEILING/ROOF FRAMING, UNLESS NOTED OR INDICATED OTHERWISE. ALL INTERIOR PARTITIONS THAT DO NOT EXTEND TO THE FRAMING SHALL BE BRACED TO THE STRUCTURE AS REQUIRED TO PREVENT MOVEMENT OR DEFLECTION.

11. NOTIFY THE ARCHITECT IMMEDIATELY OF DISCREPANCIES IN THE DRAWINGS, BETWEEN THE DRAWINGS AND SPECIFICATIONS, OR BETWEEN THE DRAWINGS AND ACTUAL JOB CONDITIONS WHICH AFFECT THE EXECUTION OF THE WORK AS INTENDED. THE ARCHITECT WILL ISSUE A CLARIFICATION OR PREPARE ALTERNATE DOCUMENTS WHICH MAY BE REQUIRED.

12. THE CONTRACTOR IS RESPONSIBLE FOR COORDINATING THE WORK OF ALL TRADES, FOR CHECKING AND COORDINATING ALL CONTRACT DOCUMENTS, SUBMITTALS, FIELD CONDITIONS AND DIMENSIONS FOR ACCURACY, AND CONFIRMING THAT THE WORK IS BUILDABLE AS SHOWN AND INTENDED, BEFORE PROCEEDING WITH CONSTRUCTION. IF THERE ARE QUESTIONS REGARDING THESE OR ANY OTHER COORDINATION ISSUES, THE CONTRACTOR IS RESPONSIBLE FOR OBTAINING CLARIFICATION FROM THE ARCHITECT REGARDING THE WORK, OR ANY RELATED WORK, IN QUESTION, BEFORE PROCEEDING WITH THE WORK.

13. AREA QUANTITIES NOTED ON THE PLAN DRAWINGS ARE PROVIDED FOR INFORMATION PURPOSES ONLY. CONTRACTOR IS RESPONSIBLE FOR FIELD VERIFICATION OF ALL DIMENSIONS AND AREA CALCULATIONS UTILIZED TO DETERMINE HIS COSTS AND QUANTITIES NECESSARY TO PROVIDE ALL LABOR, MATERIALS, COMPONENTS, AND ACCESSORIES REQUIRED TO COMPLETE WORK.

14. DIMENSIONS SHOWN ARE FOR ROUGH OPENINGS; FRAMERS SHALL ALLOW NOMINAL OPENING CLEARANCES AS REQUIRED.

15. 12" FLASHING TAPE (PEEL & STICK MEMBRANE), TO BE APPLIED TO SEAL ALL CORNERS AND OPENINGS OF THE BUILDING

VISITABILITY NOTES

1. IN ACCORDANCE WITH R320.6 OF THE VISITABILITY ORDINANCE NO.20140130-021, PROVIDE ONE NO STEP ENTRANCE WITH A BEVELED THRESHOLD OF 3/8" OR LESS AND A MINIMUM 32" CLEAR OPENING DOOR.
2. IN ACCORDANCE WITH R320.3 OF THE VISITABILITY ORDINANCE NO.20140130-021, PROVIDE VISITABLE BATHROOM WITH MINIMUM CLEAR OPENING OF 30 INCHES. LATERAL 2X6 OR LARGER WOOD BLOCKING INSTALLED FLUSH WITH STUD EDGES OF BATHROOM WALLS, AND CENTERLINE OF BLOCKING MUST BE 34" FROM AND PARALLEL TO INTERIOR FLOOR LEVEL, EXCEPT PORTION DIRECTLY BEHIND THE LAVATORY.
3. IN ACCORDANCE WITH R320.4 OF THE VISITABILITY ORDINANCE NO.20140130-021, FIRST FLOOR LIGHT SWITCHES AND ENVIRONMENTAL CONTROLS TO BE PLACED AT A MAXIMUM OF 48" ABOVE FINISH FLOOR. OUTLETS AND RECEPTACLES MUST BE A MINIMUM OF 15" ABOVE FINISH FLOOR, EXCEPT FLOOR OUTLETS AND RECEPTACLES.
4. IN ACCORDANCE WITH R320.5 OF THE VISITABILITY ORDINANCE NO.20140130-021, PROVIDE MINIMUM 32" CLEAR PATH ACCESS STARTING FROM ENTRANCE (R320.6) AND ALLOWING ACCESS THROUGHOUT FIRST FLOOR AND TO THE FIRST FLOOR BATHROOM DESIGNATED UNDER R320.3
5. IN ACCORDANCE WITH R320.7 OF THE VISITABILITY ORDINANCE NO.20140130-021, PROVIDE A VISIBLE ENTRANCE APPROVED UNDER SECTION R320.6 MUST HAVE AT LEAST ONE VISITABLE ROUTE WITH A CROSS SLOPE OF NO GREATER THAN TWO PERCENT (1:50) THAT ORIGINATES FROM A GARAGE, DRIVEWAY, PUBLIC STREET, OR PUBLIC SIDEWALK. A RAMP INCLUDED IN AN EXTERIOR VISITABLE ROUTE MUST COMPLY WITH THE RESIDENTIAL CODE.

RCP NOTES

1. CONTRACTOR SHALL FIELD VERIFY AND CORRELATE ALL DIMENSIONS ON THE JOBSITE.
2. DIMENSIONS INDICATED ON THE REFLECTED CEILING PLAN ARE TO THE FACE OF GYPSUM BOARD PARTITIONS OR FURRING ASSEMBLIES, THE FACE OF MASONRY SURFACES, WINDOWS FRAMES, AND GRID LINES, AND TO THE CENTER LINE OF LIGHT FIXTURES, CEILING FANS, SUPPLY AIR DIFFUSERS, EXHAUST AND RETURN AIR GRILLES, ETC., UNLESS NOTED OTHERWISE.
3. CONTRACTOR TO LOCATE AND LAYOUT CEILING SYSTEM AND CEILING MOUNTED FIXTURES AND OTHER ITEMS AS THEY RELATE TO THE STRUCTURE AND OTHER BUILDING ELEMENTS AS SHOWN ON THE DRAWINGS, AND IN CONFORMANCE WITH THE DESIGN CONCEPT AND INTENT.
4. CEILING MOUNTED ELEMENTS, RECESSED LIGHT FIXTURES, MECHANICAL DIFFUSERS AND GRILLES, SPEAKERS, SMOKE DETECTORS, CEILING FANS, SURFACE MOUNTED TRACK LIGHTING SYSTEMS, ETC., SHALL BE CENTERED IN EACH ROOM, UNLESS NOTED OTHERWISE.
5. REFER TO THE MECHANICAL AND ELECTRICAL PLAN SYMBOL SCHEDULES.
6. REFER TO THE ROOM FINISH SCHEDULE FOR CEILING SYSTEM MATERIALS AND FINISHES. CEILING HEIGHTS ARE NOTED ON THE FLOOR AND THE REFLECTED CEILING PLANS AND THE BUILDING SECTIONS.
7. COORDINATE ALL WORK WITH OTHER TRADES. REFER TO THE PLUMBING, MECHANICAL AND ELECTRICAL DRAWINGS AS REQUIRED.
8. TYPICAL CEILINGS TO BE PAINTED GYPSUM BOARD CEILING SYSTEM, UNLESS NOTED OTHERWISE, WITH CEILING OFFSETS AND FURR DOWNS AS INDICATED.
9. PROVIDE RECESSED FLUSH MOUNTED ACCESS PANELS TO PLUMBING, MECHANICAL AND ELECTRICAL EQUIPMENT LOCATED ABOVE THE FINISH CEILING IN ALL SUSPENDED GYPSUM BOARD CEILINGS AS REQUIRED.
10. NOTIFY ARCHITECT FOR OBSERVATION OF THE ABOVE CEILING MEP WORK PRIOR TO THE INSTALLATION OF GYPSUM BOARD CEILINGS.
11. USE 2"x4" FRAMING FOR ALL FURR DOWNS.

ELECTRICAL NOTES

1. LAYOUT SHOWN IS SCHEMATIC ONLY. ELECTRICAL CONTRACTOR SHALL DESIGN AND FURNISH ELECTRICAL SYSTEM IN CONFORMANCE WITH ALL APPLICABLE CODES.
2. COORDINATE WITH HVAC INSTALLER TO PROVIDE POWER FOR ALL MECHANICAL UNITS.
3. PROVIDE NEW DISTRIBUTION PANELS AS REQUIRED, COORDINATE LOCATION WITH BUILDING DESIGNER.
4. COORDINATE WITH PLUMBING CONTRACTOR TO PROVIDE POWER FOR TANK-LESS WATER HEATER WITH ELECTRIC IGNITION CONTROLS, GARBAGE DISPOSALS, EJECTOR AND OTHER EQUIPMENT WHERE INDICATED OR NOTED.
5. VERIFY POWER REQUIREMENT FOR APPLIANCES WITH ARCHITECT/GENERAL CONTRACTOR.
6. BUILDING SERVICE TO ELECTRICAL PANELS SHALL BE OVERHEAD.
7. CONDUCTORS: COPPER, ROMEX, INSULATED UL APPROVED, PER COA CODE AND NEC.
8. PANELS, SWITCHGEAR: MAIN DISTRIBUTION PANELS SHALL BE EQUIPPED WITH APPROPRIATE NUMBER AND SIZE OF CIRCUIT BREAKERS/ PROVIDE MIN. OF FOUR SPARES, BLANK WITHOUT CIRCUIT BREAKERS.
9. PROVIDE DIRECTORY IDENTIFYING ALL CIRCUITS AND ROOM NAMES FOR COMPLETED ELECTRICAL SYSTEM, MOUNTED ON INSIDE FRONT CORNER OF PANEL.
10. OUTLET BOXES AND BOXES FOR LIGHT FIXTURES AND SWITCH BOXES SHALL BE PLASTIC. UL APPROVED, PER COA CODE, BY PASS AND SEYMOUR OR EQUAL. PROVIDE SPECIAL GALVANIZED METAL BOXES FOR CEILING FANS. PROVIDE GALVANIZED METAL BOXES IN MASONRY OR CEMENT PLASTER WALLS.
11. WIRING DEVICES: SWITCHES AND RECEPTACLES: UL APPROVED BY PASS AND SEYMOUR OR EQUAL. SWITCHES SHALL BE SILENT TYPE. DECORATOR SWITCHES APPROVED BY ARCHITECT. DIMMER SWITCHES, UL APPROVED BY LUTRON, TYPE APPROVED BY ARCHITECT.
12. DEVICE PLATES: PLASTIC, BY PASS AND SEYMOUR OR LUTRON, OR EQUAL, COLOR APPROVED BY ARCHITECT.
13. IN GENERAL, WALL OUTLET BOXES FOR RECEPTACLES SHALL BE MOUNTED AT 15" AFF TO CENTERLINE, TYPICAL AND BOXES FOR SWITCHES AND DIMMERS SHALL BE MOUNTED AT 48" AFF TO CENTERLINE, TYPICAL.
14. FIELD VERIFY AND COORDINATE WITH ARCHITECT REGARDING MOUNTING HEIGHTS AND LOCATIONS AND FINISH THICKNESSES FOR OUTLET BOXES AT KITCHEN AND BATHROOM CABINETS AND COUNTERTOPS, BACK AND END SPLASHES, AND OTHER SPECIAL CONDITIONS.
15. ALL OUTLETS IN ALL LOCATIONS SHOULD BE ARC FAULT PER 210.12 OF NFPA 70 (IBC 2012), UNLESS NOTED OTHERWISE.
16. ALL OUTLETS IN BATHROOMS, LAUNDRY ROOMS, GARAGES, ACCESSORY BUILDINGS AND EXTERIOR TO BE GROUND-FAULT CIRCUIT INTERRUPT. AS WELL AS ALL LOCATIONS IN A KITCHEN THAT SERVICE COUNTERTOP SURFACES AND WITHIN 6FT OF THE EDGE OF SINK, BATHTUB, OR SHOWER STALL.
17. ALL OUTDOOR OUTLETS AND LIGHTS SHOULD BE ON A GROUND FAULT BREAKER.



PLUMBING NOTES

1. CONTRACTOR SHALL VERIFY AND COORDINATE THE EXACT LOCATION OF PIPING, FITTINGS, OFFSETS, BENDS, DEVICES AND EQUIPMENT WITH EXISTING SITE CONDITIONS, THE BUILDING ELEMENTS AND THE WORK OF OTHER TRADES.
2. ALL WORK, INCLUDING MATERIALS AND WORKMANSHIP, SHALL CONFORM TO THE REQUIREMENTS OF LOCAL CODES, LAWS AND ORDINANCES, THE UNIFORM MECHANICAL, PLUMBING AND BUILDING CODES, THE WORK SHALL BE COMPLETE IN ALL RESPECTS AND IN ACCORDANCE WITH ACCEPTED AND ESTABLISHED CONSTRUCTION PRACTICES.
3. THE COLD AND HOT WATER PLUMBING SYSTEMS ARE NOT SHOWN ON THE DRAWINGS.
4. WATER HEATER: NATURAL GAS WHOLE HOUSE TANK-LESS WATER HEATER, OUTDOOR INSTALLATION, VENT-LESS, ENERGY EFFICIENT, FREEZE PROTECTION TO FIVE DEGREES FAHRENHEIT, ELECTRONIC IGNITION, OPTIONAL REMOTE THERMOSTAT. ENDLESS HOTWATER SUPPLY FOR 2 MAJOR APPLICATIONS AT A TIME. MODEL: "AQUASTAR 2400EONG" BY BOSCH, OR "AQUASTAR 2505X0NG" OR APPROVED EQUAL OR RINNAI MODEL # R85E (2532W).
5. WATER SYSTEM PIPING: PEX, CROSS-LINKED FLEXIBLE, POLYETHYLENE PLASTIC PIPING WITH HIGH TEMPERATURE POLYMER FITINGS PROVIDE 1" THICK FOAM INSULATION AT ALL HOT WATER PIPING, AND 1/2" THICK AT ALL COLD WATER PIPING ABOVE THE SLAB, INCLUDING UNDER THE CONCRETE SLAB. PROVIDE CONTINUOUS PLASTIC SHEATHING AT ALL WATER SYSTEM PIPING PLACED BENEATH THE SLAB; COLOR CODED TO PROTECT THE TUBING - NOT SHOWN IN THIS PLAN.
6. WATER SYSTEM PIPING SHALL BE INSTALLED UNDERNEATH THE VAPOR BARRIER MEMBRANE FOR THE CONCRETE SLAB. NO JOINTS IN THE PIPING OR TUBING BENEATH THE SLAB ARE PERMITTED
7. WASTE WATER DRAIN AND VENT PIPING: PVC, SCHEDULE 40.


MECHANICAL NOTES

1. HVAC SPLIT SYSTEM NOMINAL CAPACITY IS ESTIMATED AT 3 TONS (PER UNIT), WITH 1 AIR HANDLING UNIT AND 1 CONDENSING UNIT. SYSTEM DESIGN: MULTI-POSITION BLOWER WITH HEAT PUMP OUTDOOR CONDENSING UNIT.
2. HVAC SYSTEM DUCTWORK CONSTRUCTION SHALL BE REINFORCED FOIL FACED SEMI-RIGID GLASS FIBER DUCTS (SQUARE, RECTANGULAR), WITH FLEX DUCT CONNECTIONS AT MOST REGISTERS OR DIFFUSERS. SUPPLY AIR AND RETURN AIR DUCTWORK SHALL BE MINIMUM R-8 INSULATION. FLEX DUCTWORK CONNECTIONS SHALL ALSO BE RATED MINIMUM R-8.
3. PROVIDE ENERGY EFFICIENT AIR HANDLING AND CONDENSING UNITS WITH MINIMUM 14 SEER. COMPLY WITH COA STANDARDS.
4. HIGH QUALITY RESIDENTIAL SUPPLY DIFFUSERS AND RETURN AIR GRILLES, AS APPROVED BY THE OWNER, SHALL BE PROVIDED. STAMPED METAL GRILLES WILL NOT BE ACCEPTABLE.
5. VIBRATION ISOLATION AT THE AIR HANDLING UNIT SHALL BE PROVIDED, UTILIZING MINIMUM OF 4 - 1" THICK RUBBER ISOLATION PADS.
6. MECHANICAL DESIGN/BUILD CONTRACTOR TO SUBMIT SHOP DRAWINGS AND PRODUCT DATA INFORMATION, PRIOR TO ORDERING EQUIPMENT OR MATERIALS, FOR APPROVAL BY THE OWNER AND ARCHITECT, DESCRIBING ALL OF THE MECHANICAL EQUIPMENT, DUCTWORK, INSULATION, PIPING, DIFFUSERS, GRILLES AND REGISTERS, THERMOSTATS, ACCESSORIES AND OTHER ITEMS REQUIRED TO COMPLETE THE MECHANICAL SYSTEM WORK. INDICATE ALL DUCTWORK CONSTRUCTION MATERIALS, DUCT SIZES AND AIR VOLUME CAPACITIES IN CFM AT ALL DIFFUSERS, GRILLES AND REGISTERS, TURNING VANES, LOCATIONS OF FLEX AND FIXED CONNECTIONS, VIBRATION ISOLATION DEVICES, AND OTHER APPLICABLE INFORMATION.


SYMBOL LEGEND:

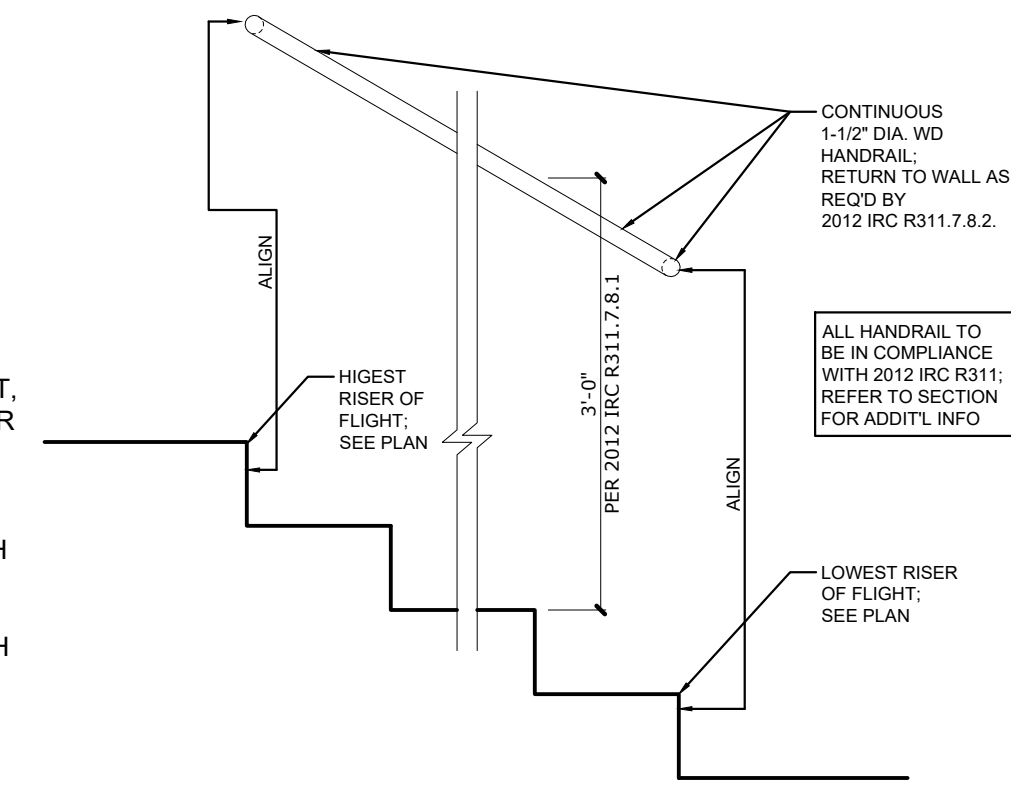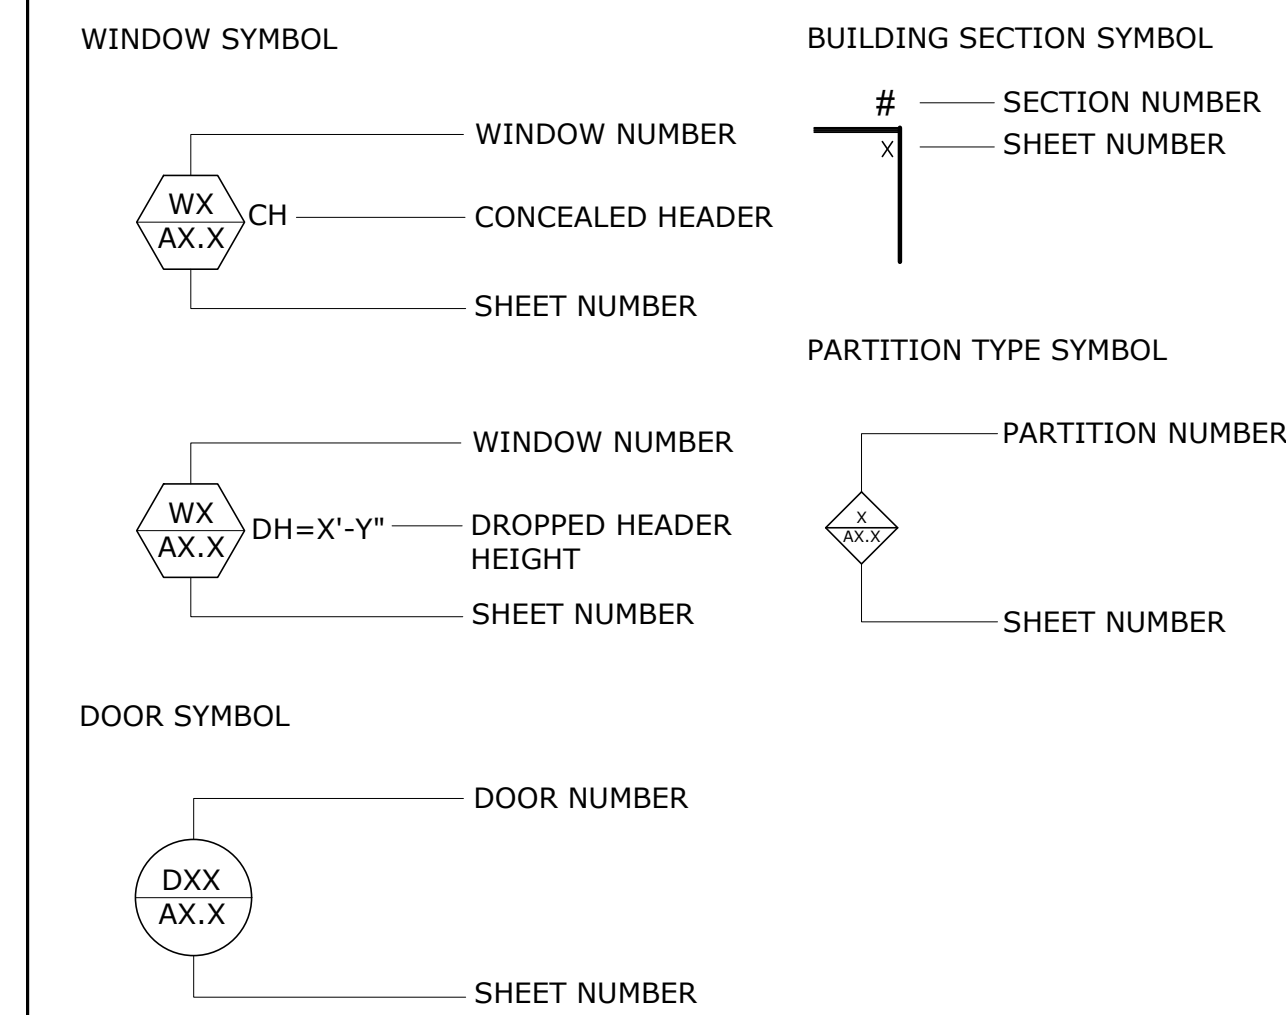


4 TYPICAL HANDRAIL DETAIL
FULL SIZE SCALE: 3/4"=1'-0"
HALF SIZE SCALE: 3/8"=1'-0"

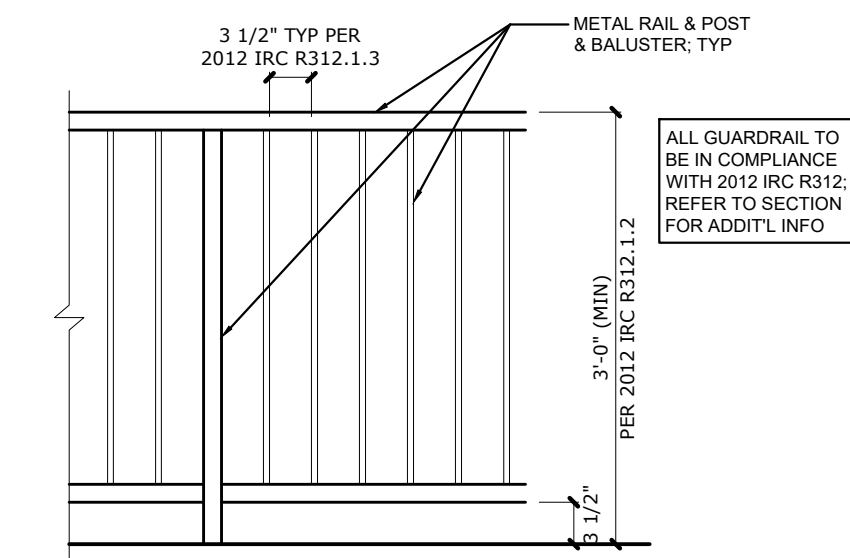

3 TYPICAL GUARDRAIL DETAIL
FULL SIZE SCALE: 3/4"=1'-0"
HALF SIZE SCALE: 3/8"=1'-0"

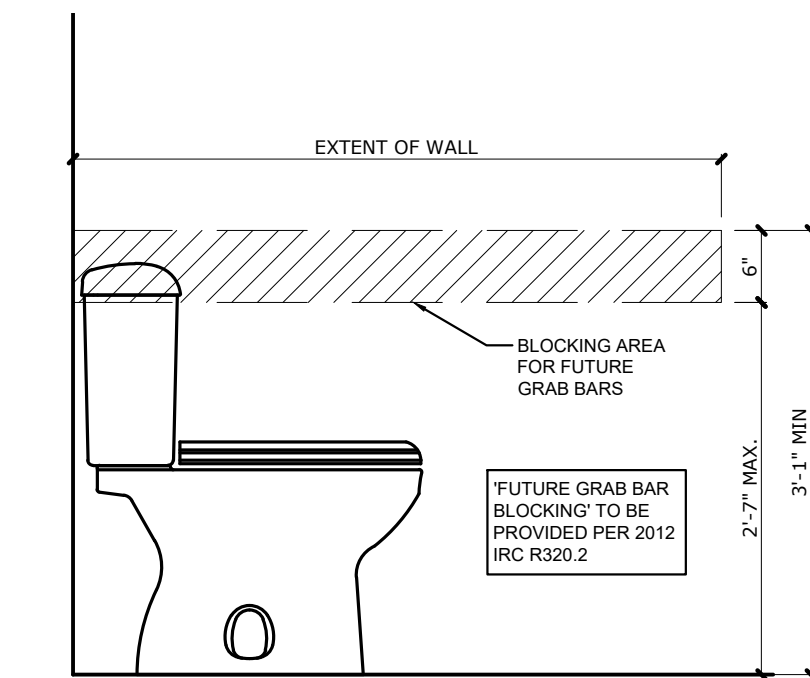

2 TYP ADA BLOCKING @ TOILET DETAIL
FULL SIZE SCALE: 3/4"=1'-0"
HALF SIZE SCALE: 3/8"=1'-0"

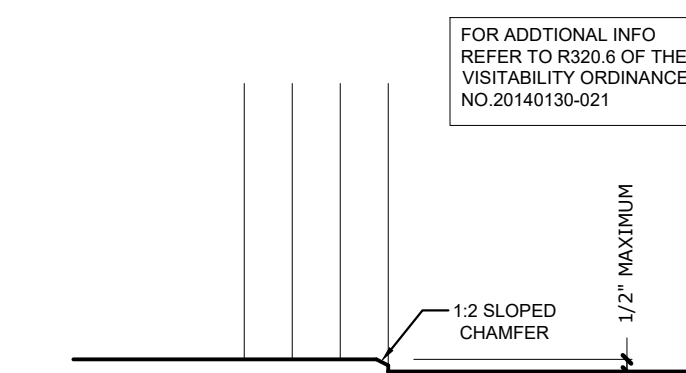

1 ADA COMPLIANT ENTRANCE
FULL SIZE SCALE: 1-1/2"=1'-0"
HALF SIZE SCALE: 3/4"=1'-0"

PROJECT

2114 PARAMOUNT

OWNER


ATX LUXURY BUILDERS

REVISIONS

NO ISSUE DATE

NOTES

SEAL & SIGNATURE

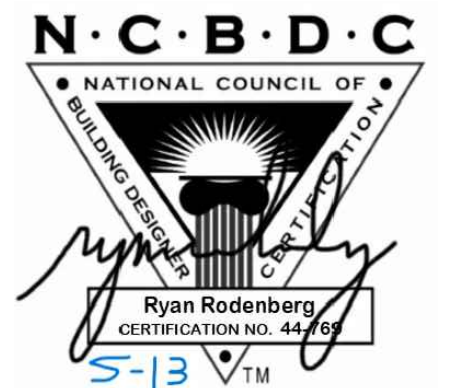

DESIGNER

R
D—O

RODENBERG DESIGN

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SHEET TITLE

GENERAL NOTES

SHEET NUMBER

A0.1

VERIFY SIZES AND HEAD HEIGHT W/ PLANS AND ELEVATIONS; CONTACT DESIGNER W/ ANY DISCREPANCIES: TEMPER NOT SPECIFIED

WINDOW SCHEDULE				
WINDOW #	SIZE	HEAD HEIGHT	TYPE	COMMENTS
A				
B	3'0"X5'0"	9'0"	FIXED	
C	3'0"X10'0"	10'0"	FIXED	
D		9'0"	FIXED	MULLED; SEE ELEVATION
E	4'0"X7'0"	9'0"	FIXED	
F	7'0"X7'0"	9'0"	FIXED	
G	3'0"X6'0"	8'0"	CASEMENT	EGRESS
H	3'0"X3'0"	9'0"	FIXED	
I	3'0"X6'0"	9'0"	FIXED	
J	4'0"X8'0"	9'0"	FIXED	
K	4'0"X8'0"	9'0"	FIXED	
L	7'0"X5'0"	9'0"	FIXED	
M	8'0"X9'0"	10'0"	FIXED	
N	4'0"X2'0"	9'0"	FIXED	
O	3'0"X6'0"	8'0"	CASEMENT	EGRESS
P	5'0"X6'0"	8'0"	FIXED	
Q	3'0"X6'0"	8'0"	CASEMENT	EGRESS
R	5'0"X6'0"	8'0"	FIXED	
S	3'0"X7'0"	8'0"	FIXED	
T	8'0"X7'0"	8'0"	FIXED	
U	8'0"X7'0"	8'0"	FIXED	
V	8'0"X7'0"	8'0"	FIXED	
W	8'0"X7'0"	8'0"	FIXED	
X	4'0"X4'0"	8'0"	FIXED	
Y	7'0"X7'0"	8'0"	FIXED	
Z	4'0"X3'0"	8'0"	FIXED	
AA	8'0"X7'0"	8'0"	FIXED	
BB	3'0"X6'0"	8'0"	FIXED	
CC	3'0"X6'0"	8'0"	CASEMENT	EGRESS
DD	8'0"X7'0"	8'0"	FIXED	
EE	2'0"X3'0"	8'0"	FIXED	

DOOR SCHEDULE			
DOOR #	SIZE	INT / EX	COMMENTS
1	16'X8'0"	EX	GARAGE
2	3'0"X8'0"	INT	ACCESSIBLE ROUTE DOOR - ADA THRESHOLD
3	2'6"X8'0"	INT	POCKET DOOR
4	4'X10'0"	EX	FULL LITE ENTRY DOOR
5	2'6"X8'0"	INT	
6	2'8"X8'0"	INT	ACCESSIBLE ROUTE DOOR
7	2'8"X8'0"	INT	
8	2'8"X8'0"	INT	
9	2'6"X8'0"	INT	POCKET DOOR
10	2'6"X8'0"	INT	POCKET DOOR
11	2'6"X8'0"	INT	POCKET DOOR
12	8'0"X9'0"	EX	2 PANEL SLIDER
13	16'0"X10'0"	EX	4 PANEL SLIDER
14	12'0"X9'0"	EX	3 PANEL SLIDER
15	2'6"X8'0"	INT	
16	4'0"X8'0"	INT	DOUBLE DOORS
17	2'6"X8'0"	INT	POCKET DOOR
18	2'6"X8'0"	INT	POCKET DOOR
19	2'6"X8'0"	INT	
20	2'6"X8'0"	INT	
21	2'6"X8'0"	INT	
22	2'6"X8'0"	INT	POCKET DOOR
23	2'6"X8'0"	INT	
24	16'0"X8'0"	EX	4 PANEL SLIDER
25	3'0"X8'0"	INT	
26	2'6"X8'0"	INT	POCKET DOOR
27	3'0"X8'0"	INT	
28	3'0"X8'0"	INT	POCKET DOOR
29	2'6"X8'0"	INT	POCKET DOOR
30	2'6"X8'0"	INT	POCKET DOOR

DOOR NOTES
 - UNLESS OTHERWISE NOTED ALL DOORS TO BE FLUSH PANEL AND SOLID CORE
 - ALL BASEBOARDS AND DOOR TRIM TBD



DESIGNER




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SHEET TITLE

SCHEDULES

SHEET NUMBER

A0.2

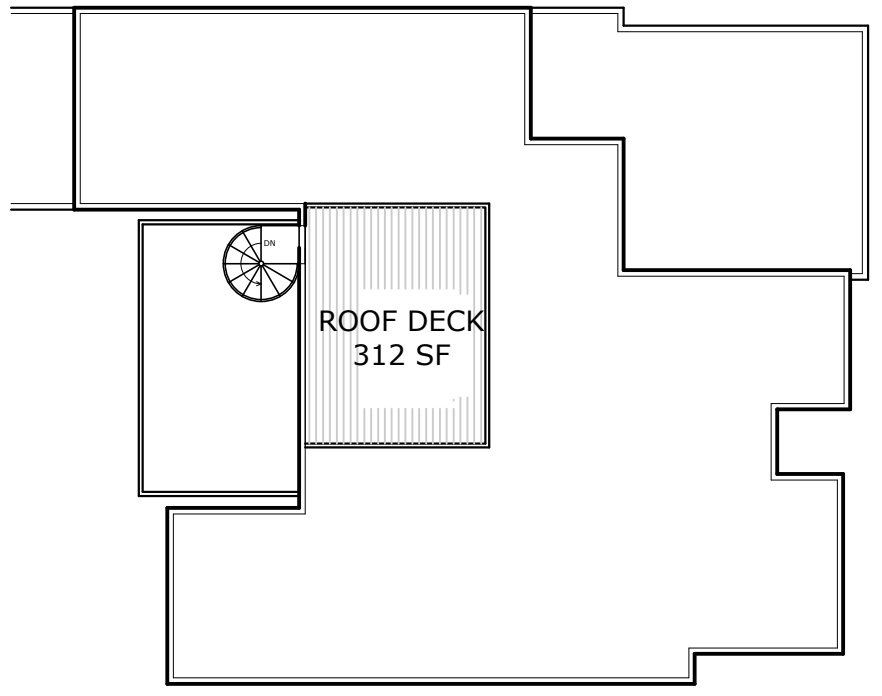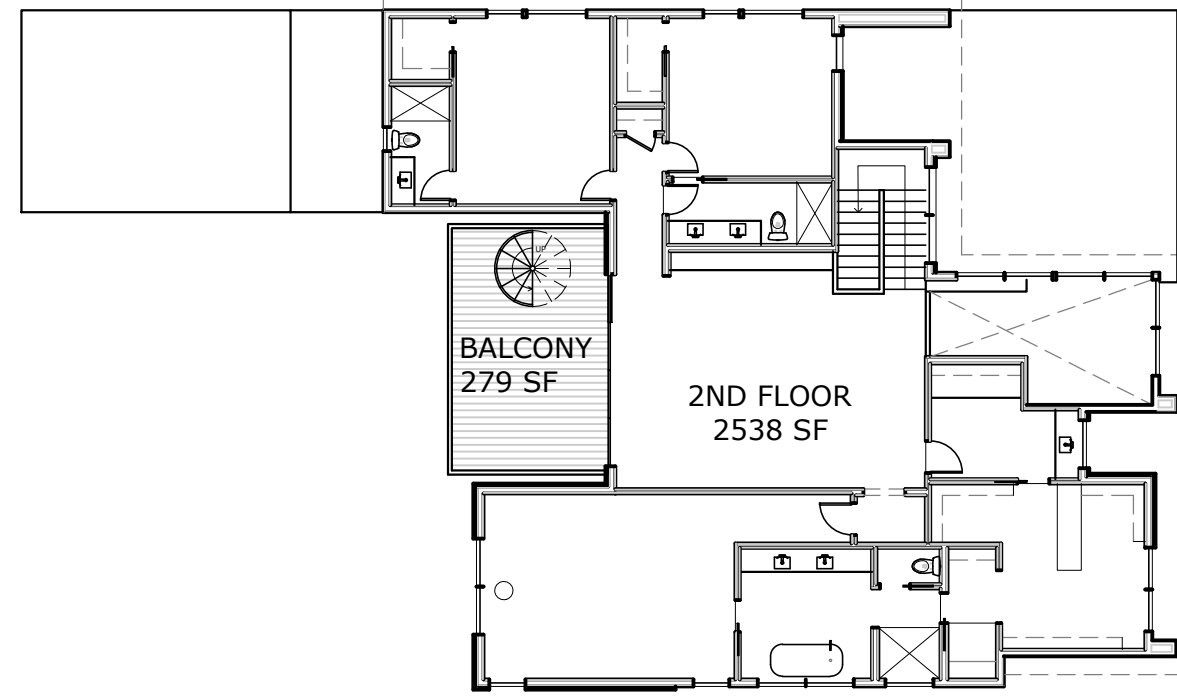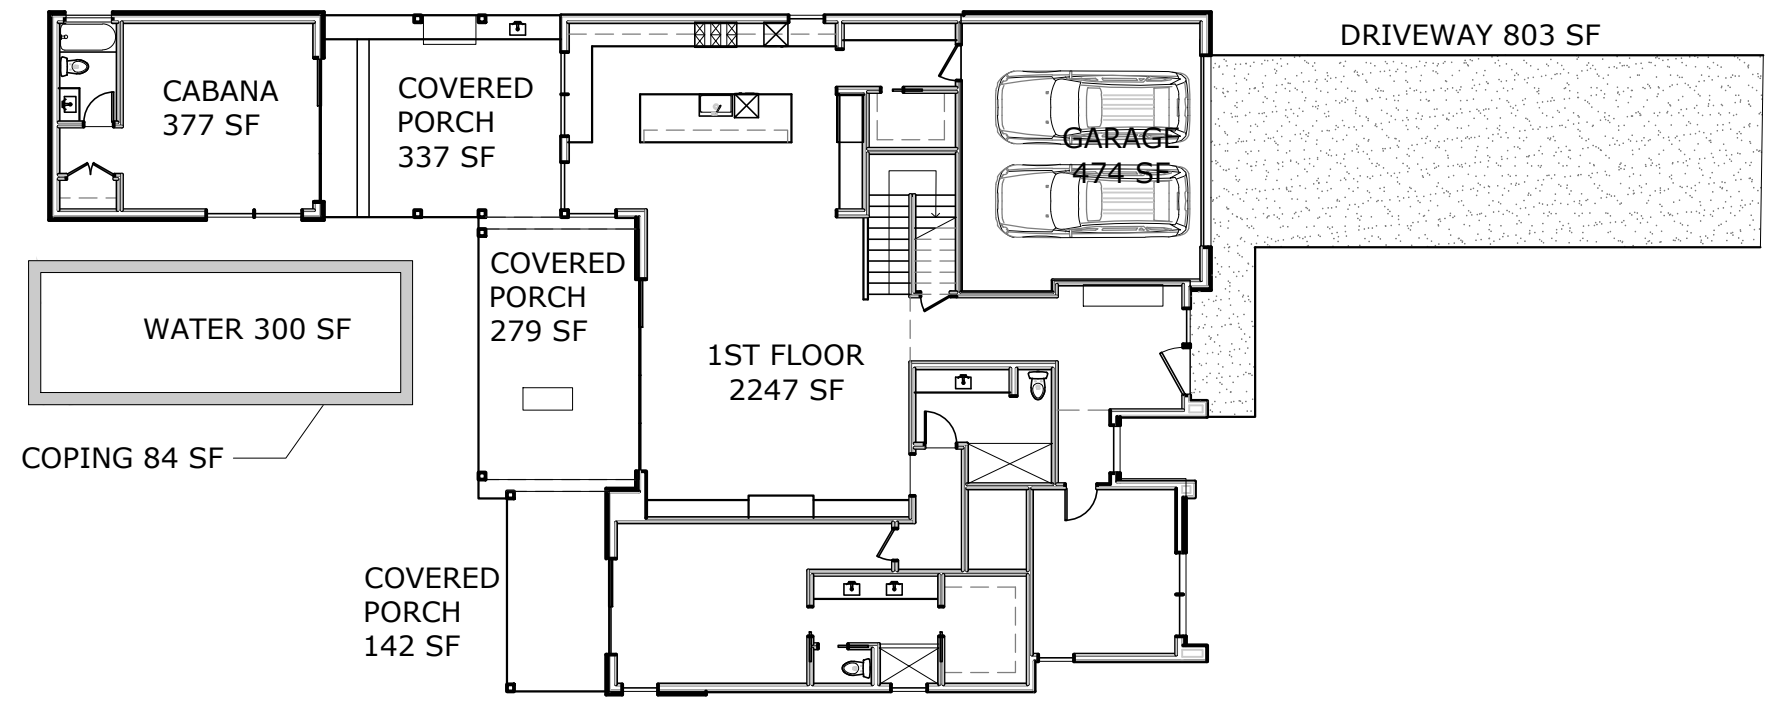

02 Area Calculations
 1/16" = 1'-0" @ 22x34 1/32" = 1'-0" @ 11x17

Visitability Notes


1. Light switches and environmental controls to be installed maximum 48" above the interior floor level.
2. Outlets and receptacles to be installed minimum 15" above interior floor level (except for floor outlets).

Visitability Entrance


1. Door to be 3'-0" x 8'-0" minimum.
2. Landing to be 3'-0" x 3'-0" minimum with maximum slope of 1/4"/ft.
3. If foundation plan shows more than 1 1/2" drop, design professional must provide threshold detail.

Visitability Bathroom

1. Door to be 3'-0" x 8'-0" minimum.
2. 2x6 blocking, centerline at 34" above finish floor (except behind lavatory).

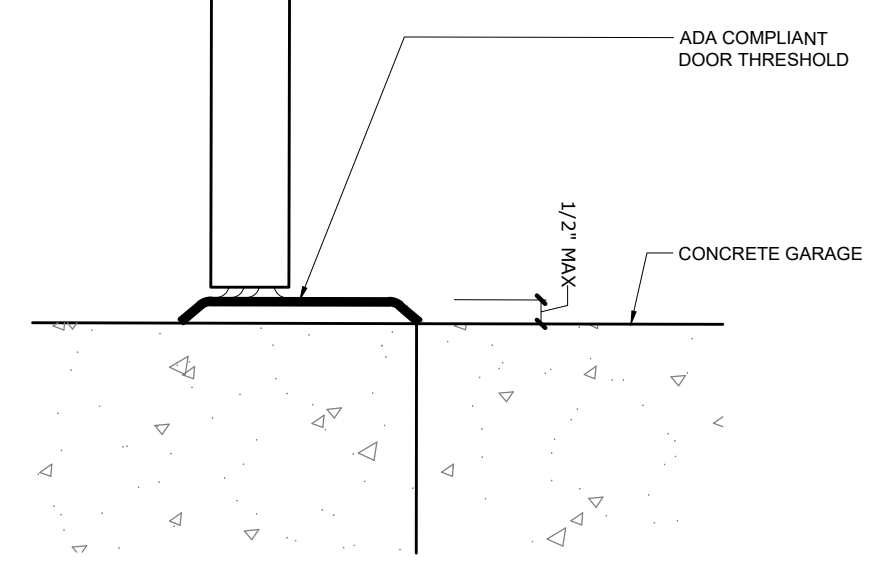

03 Threshold Detail at Entrance
 3" = 1'-0" @ 22x34 1 1/2" = 1'-0" @ 11x17

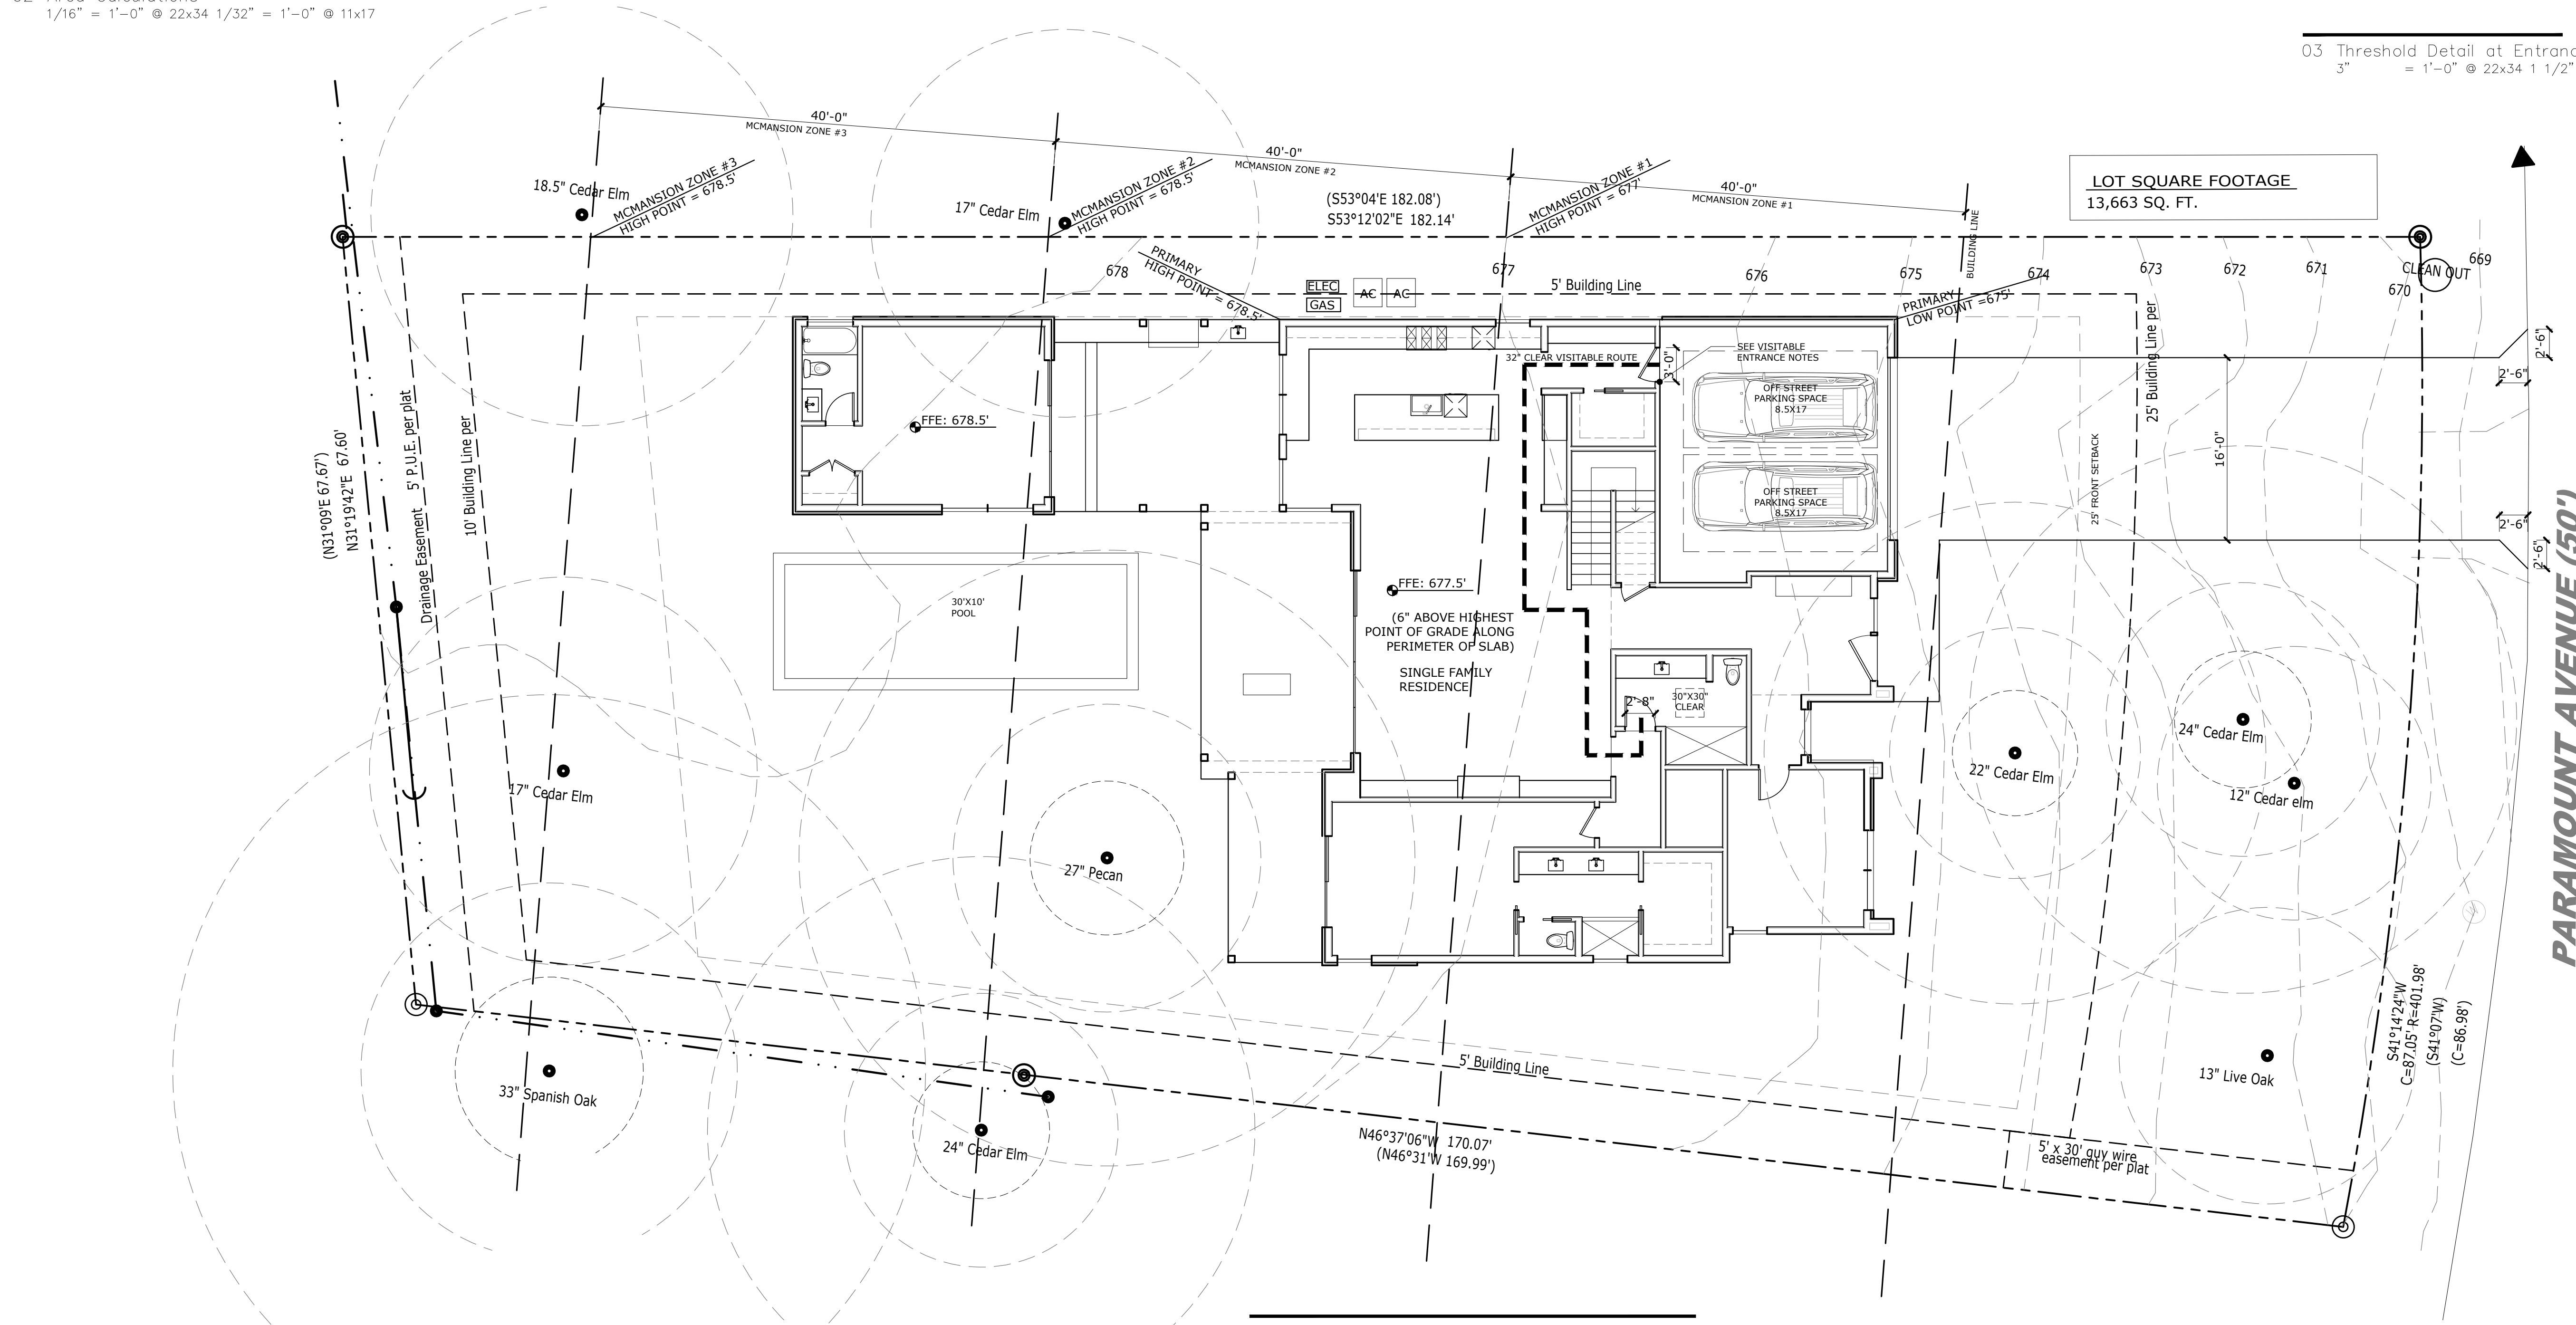

01 Site Plan
 1/8" = 1'-0" @ 22x34 1/16" = 1'-0" @ 11x17

PROJECT
2114 PARAMOUNT

OWNER
ATX LUXURY BUILDERS

REVISIONS

NO	ISSUE	DATE

NOTES



DESIGNER

R
D — O


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SHEET TITLE

SITE PLAN

SHEET NUMBER

A1.0

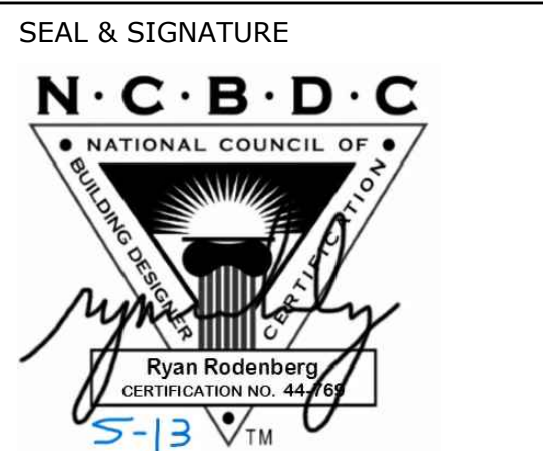

DESIGNER

R
D — O

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SHEET TITLE

TREE PLAN

SHEET NUMBER


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TREE NOTES

In order to assure that the remaining root zones are adequately preserved, tree protection fencing is required for all trees within the limits of construction. Fencing should be indicated to protect the entire Critical Root Zone (CRZ) area or as much of the CRZ as is practical. Fencing is required to be chain-link mesh at a minimum height of five feet. When the tree protection fencing cannot incorporate the entire 1/2 Critical Root Zone, an eight inch layer of mulch within the entire available root zone area is required for all trees which have any disturbance indicated within any portion of the Critical Root Zone.

Foot traffic is considered a root zone disturbance, as well. We require 2x4 or greater size planks (6' tall minimum) to be strapped securely around protected trees trunks and root flares when protective fencing does not incorporate the entire 1/2 CRZ for any reason at any time in the project.

Any area of full CRZ that is not fenced in requires 8" of mulch.

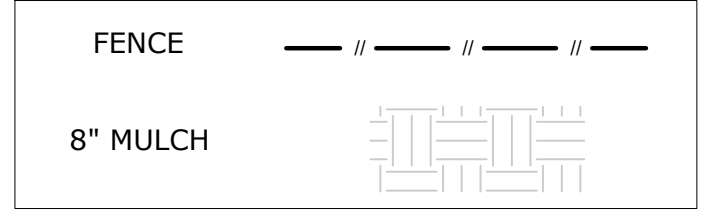

No batter board or foundation formwork stakes within the 1/2 CRZ except #5 rebar w/pointed tip. Use a strong-back design to get any larger stakes out of the 1/2 CRZ.


ALL PROPOSED UTILITY ROUTES AND METER LOCATIONS ARE TO AVOID THE 1/2 CRZ OF ANY PROTECTED TREE

IF TRENCHING WITHIN THE 1/2 CRZ OF PROTECTED TREES CANNOT BE AVOIDED, THE TRENCHES WILL HAVE TO BE AIR SPACED BY A QUALIFIED ARBORIST FOR THE TOP 30" TO AVOID CUTTING ROOTS 1.5" IN DIAMETER

LOT SQUARE FOOTAGE
13,663 SQ. FT.

TOTAL CRZ SF: 2290 SF
COVERAGE OF FULL CRZ = 710 SF (31%)

01 Tree Plan
3/16" = 1'-0" @ 22x34 3/32" = 1'-0" @ 11x17

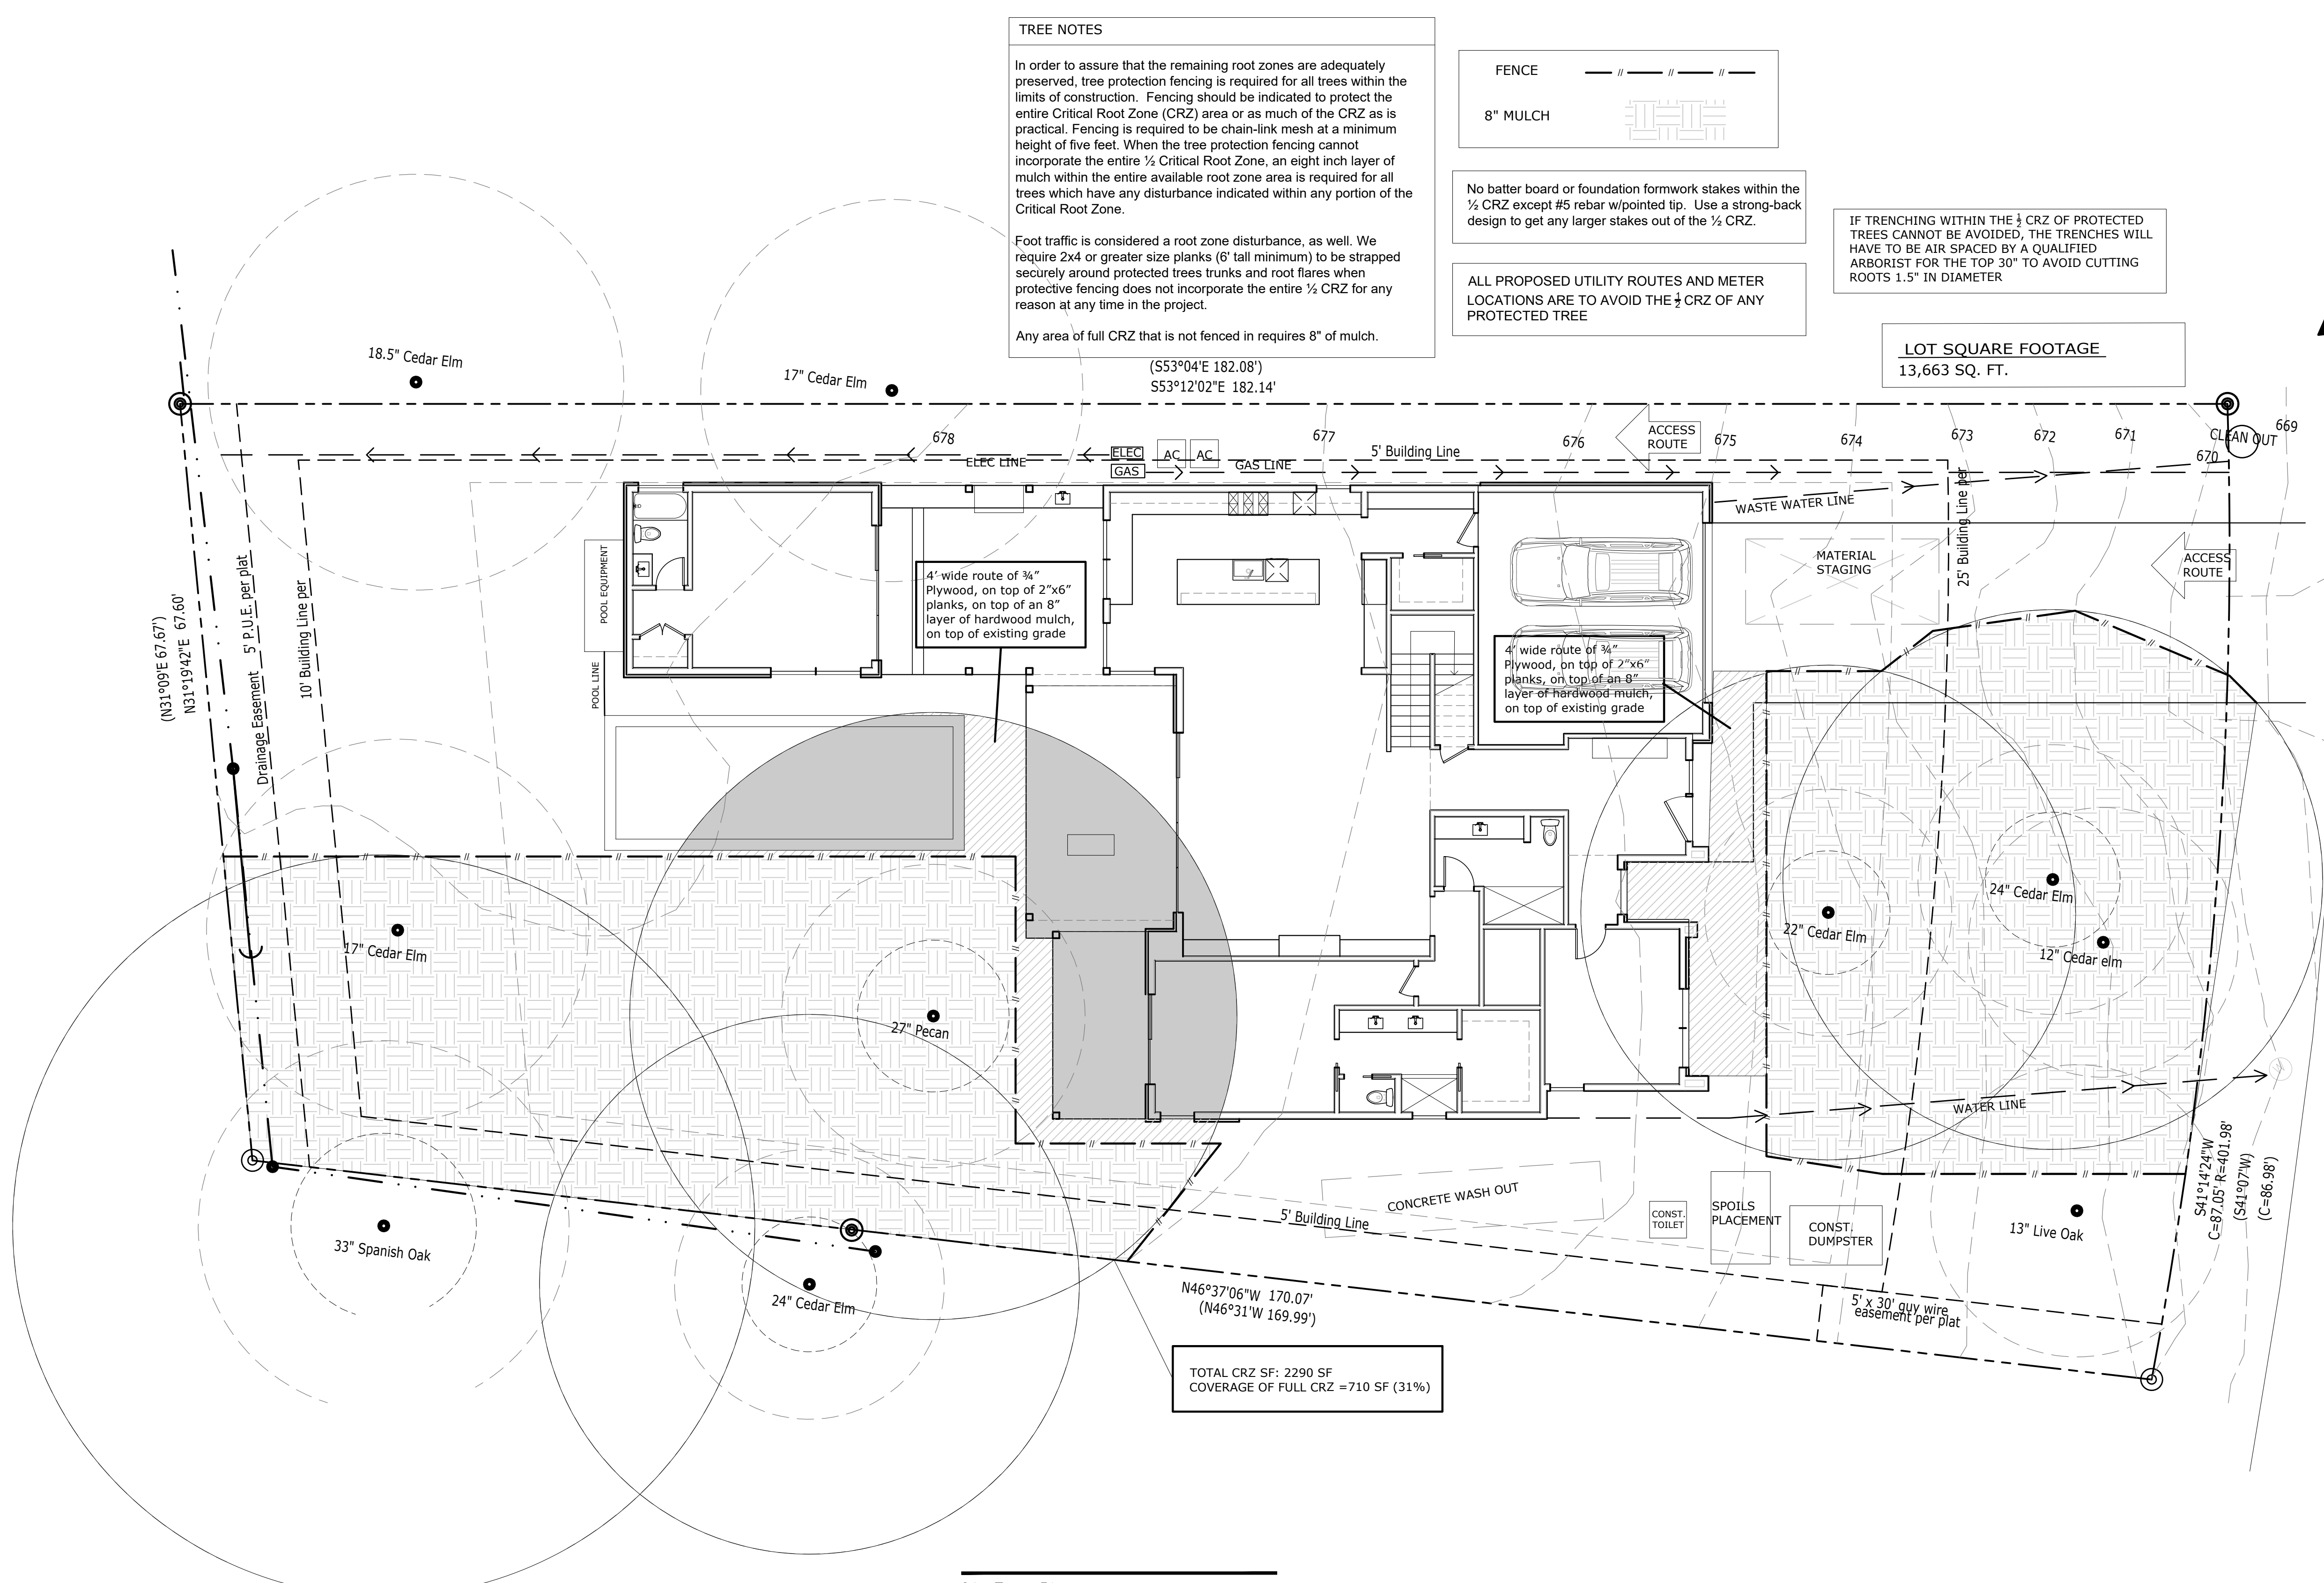

General Notes


- All walls to be 2x4; plumbing walls to be 2x6; insulate exterior walls, R-19 min.
- All doors to be 96" height
- 5/8" drywall gypsum board throughout
- Green board in showers and wet areas
- Shoot all plates w/ 2x Ramset w/in 6" of cut

Plan Notes

- All egress windows and doors to comply with 2021 IRC R310.1, R311.2, R312.2
- Stairs, handrails, and guardrails to comply with 2021 IRC R311.5.1, R311.7, R312.1
- First floor of new construction with any living space to comply with all visibility standards under city code section 25-12-243, R320. Visibility items are referenced on floor plans

Legend

- Ⓢ Smoke detector installed in accordance with IRC 2021 R314
- Ⓜ Carbon monoxide detector installed in accordance with IRC 2021 R315

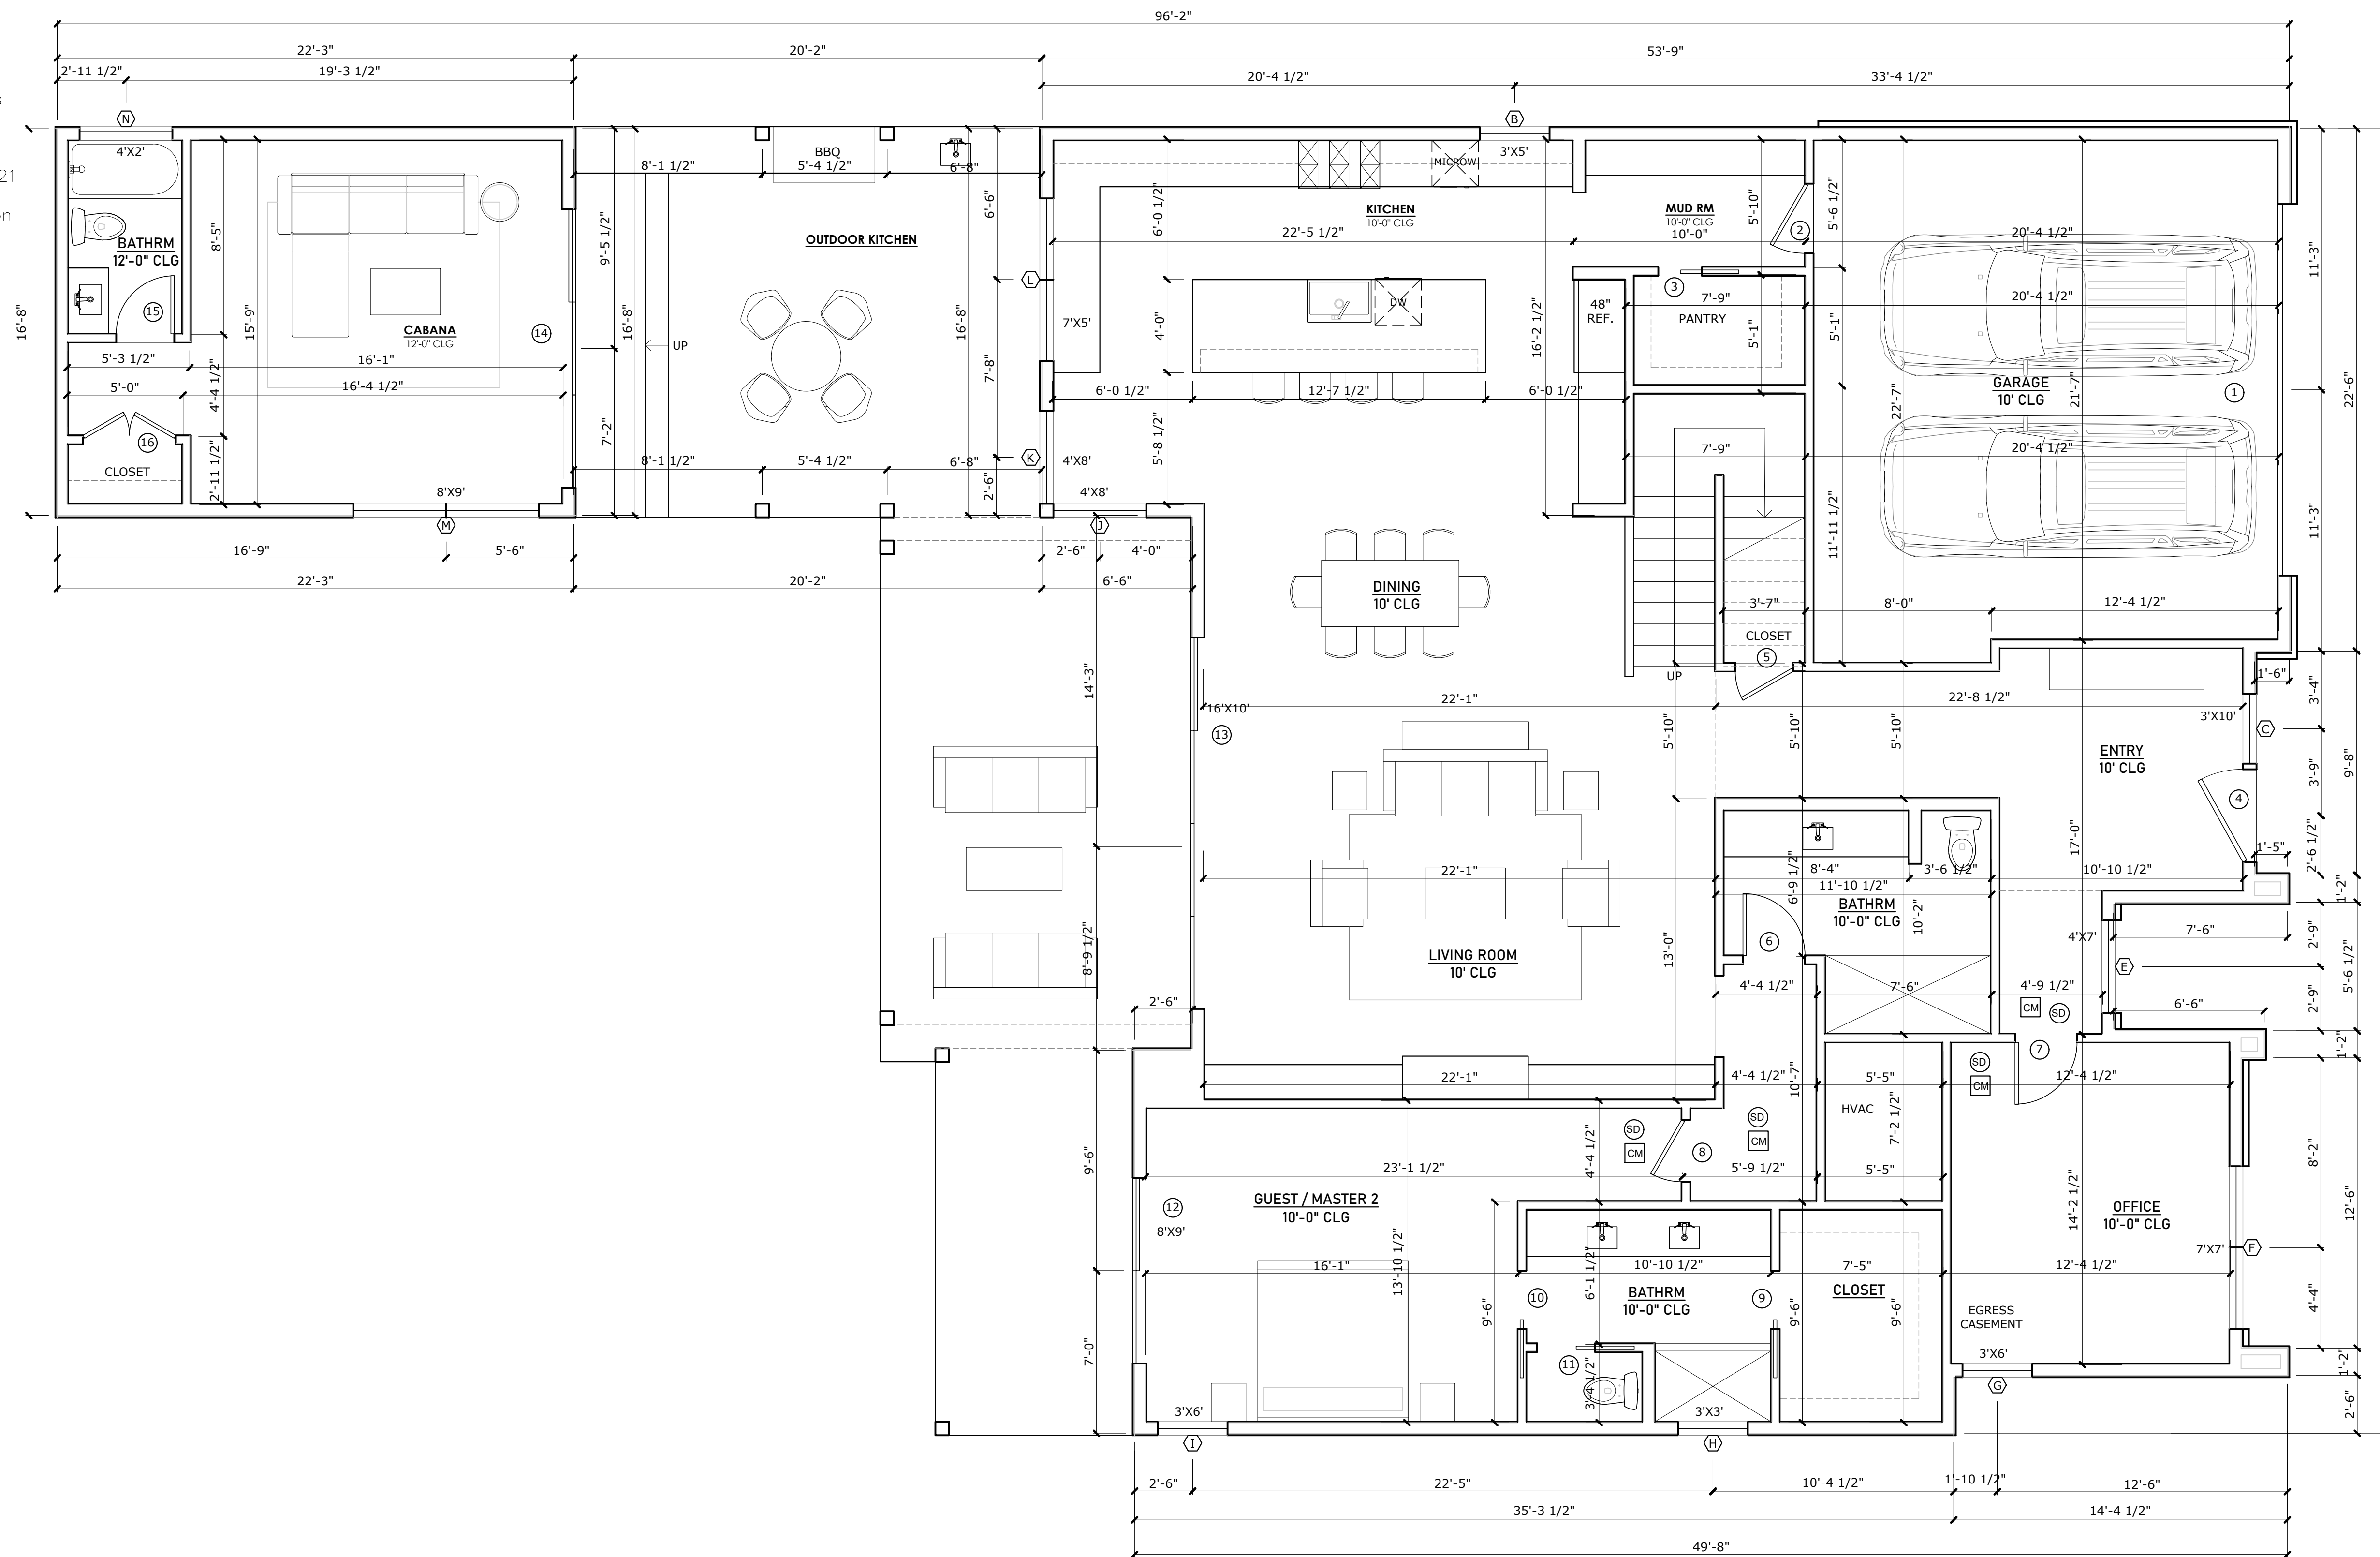

01 First Floor Plan
 1/4" = 1'-0" @ 22x34 1/8" = 1'-0" @ 11x17

PROJECT

2114 PARAMOUNT

OWNER


ATX LUXURY BUILDERS

REVISIONS

NO	ISSUE	DATE

NOTES

SEAL & SIGNATURE

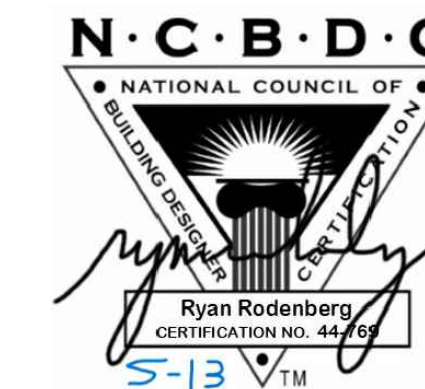

DESIGNER

R
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SHEET TITLE

FIRST FLOOR
 PLAN

SHEET NUMBER

A2.0

General Notes


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2. All doors to be 96" height
3. 5/8" gypsum board throughout
4. Green board in showers and wet areas
5. Shoot all plates w/ 2x Ramset w/in 6" of cut

Plan Notes

1. All egress windows and doors to comply with 2021 IRC R310.1, R311.2, R312.2
2. Stairs, handrails, and guardrails to comply with 2021 IRC R311.5.1, R311.7, R312.1
3. First floor of new construction with any living space to comply with all visitability standards under city code section 25-12-243, R320. Visitability items are referenced on floor plans

Legend

- ☉ Smoke detector installed in accordance with IRC 2021 R314
- ☒ Carbon monoxide detector installed in accordance with IRC 2021 R315

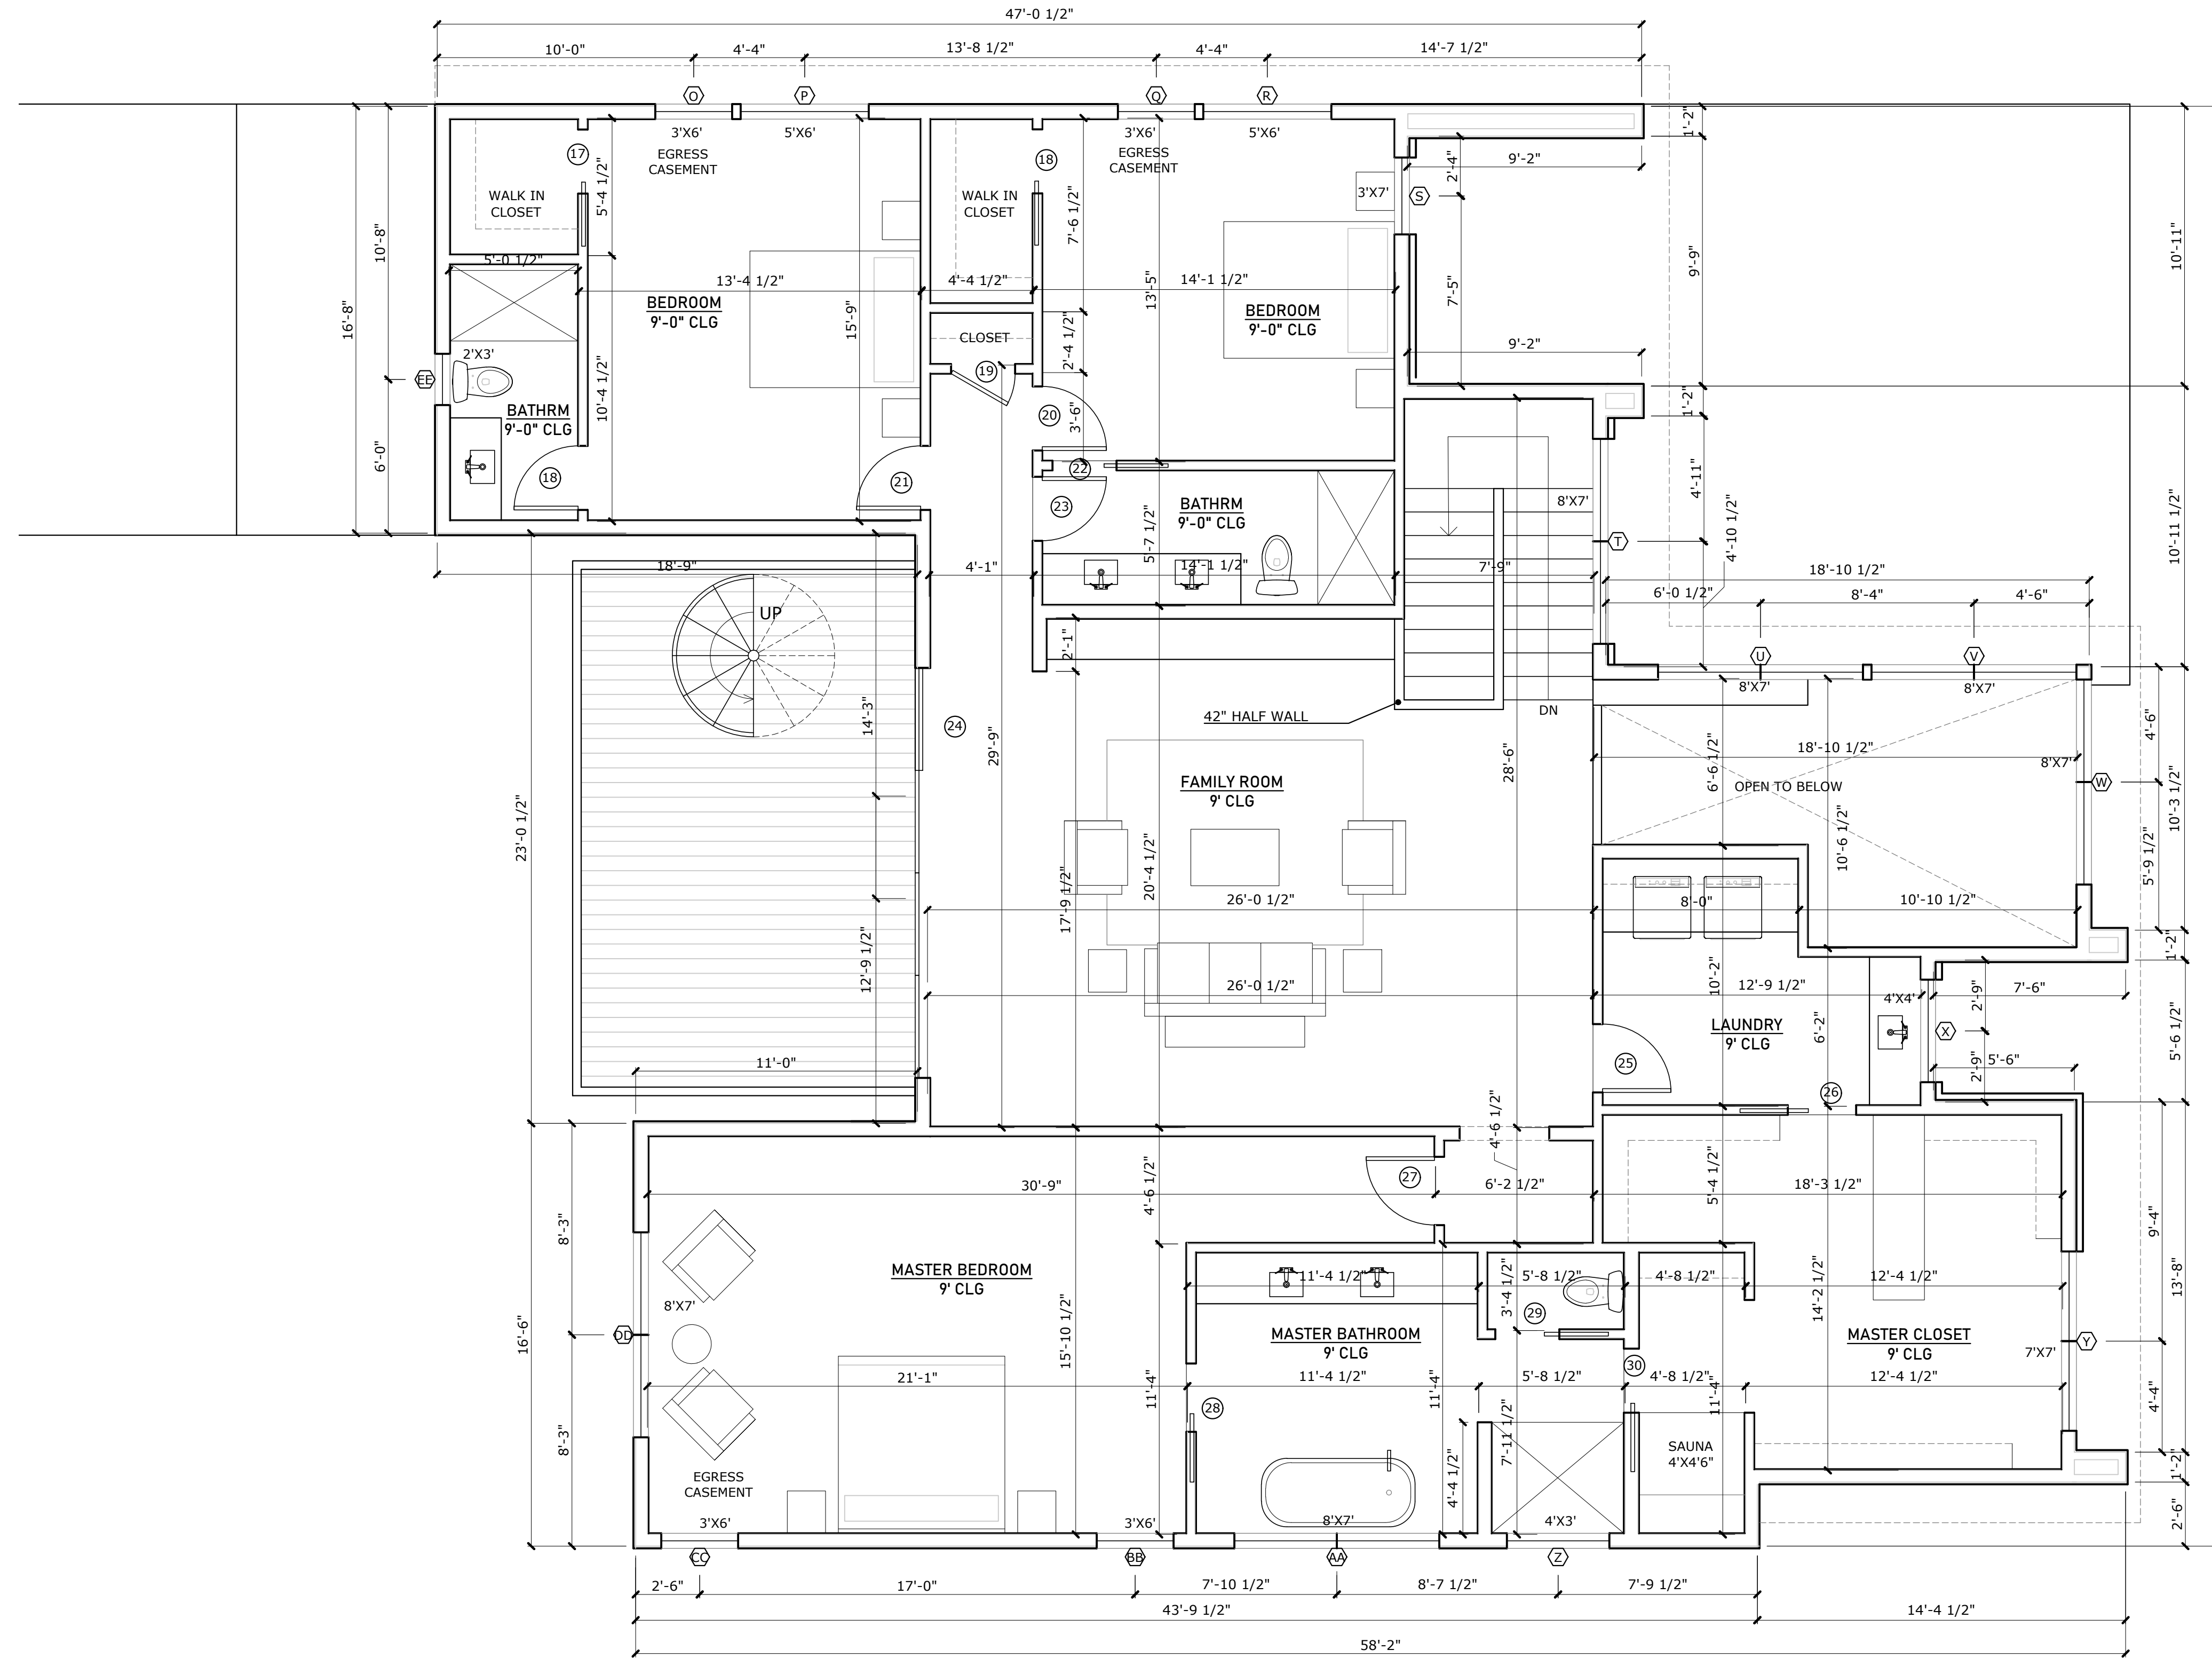


01 Second Floor Plan
 1/4" = 1'-0" @ 22x34
 1/8" = 1'-0" @ 11x17

PROJECT
2114 PARAMOUNT

OWNER
ATX LUXURY BUILDERS

REVISIONS		
NO	ISSUE	DATE

NOTES

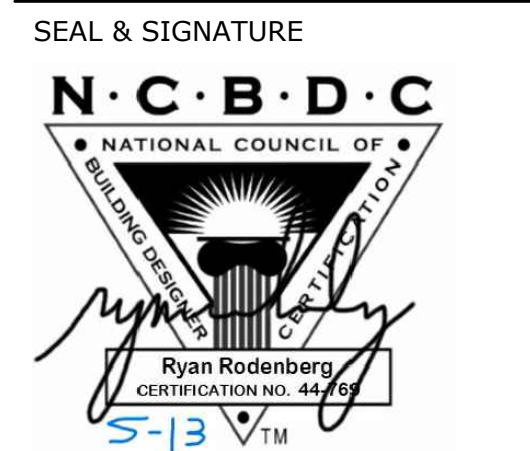

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SHEET TITLE
2ND FLOOR PLAN

SHEET NUMBER
A2.1

General Notes


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Plan Notes

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Legend

- ☉ Smoke detector installed in accordance with IRC 2021 R314
- ☒ Carbon monoxide detector installed in accordance with IRC 2021 R315



01 Roof Plan
 1/4" = 1'-0" © 22x34 1/8" = 1'-0" © 11x17

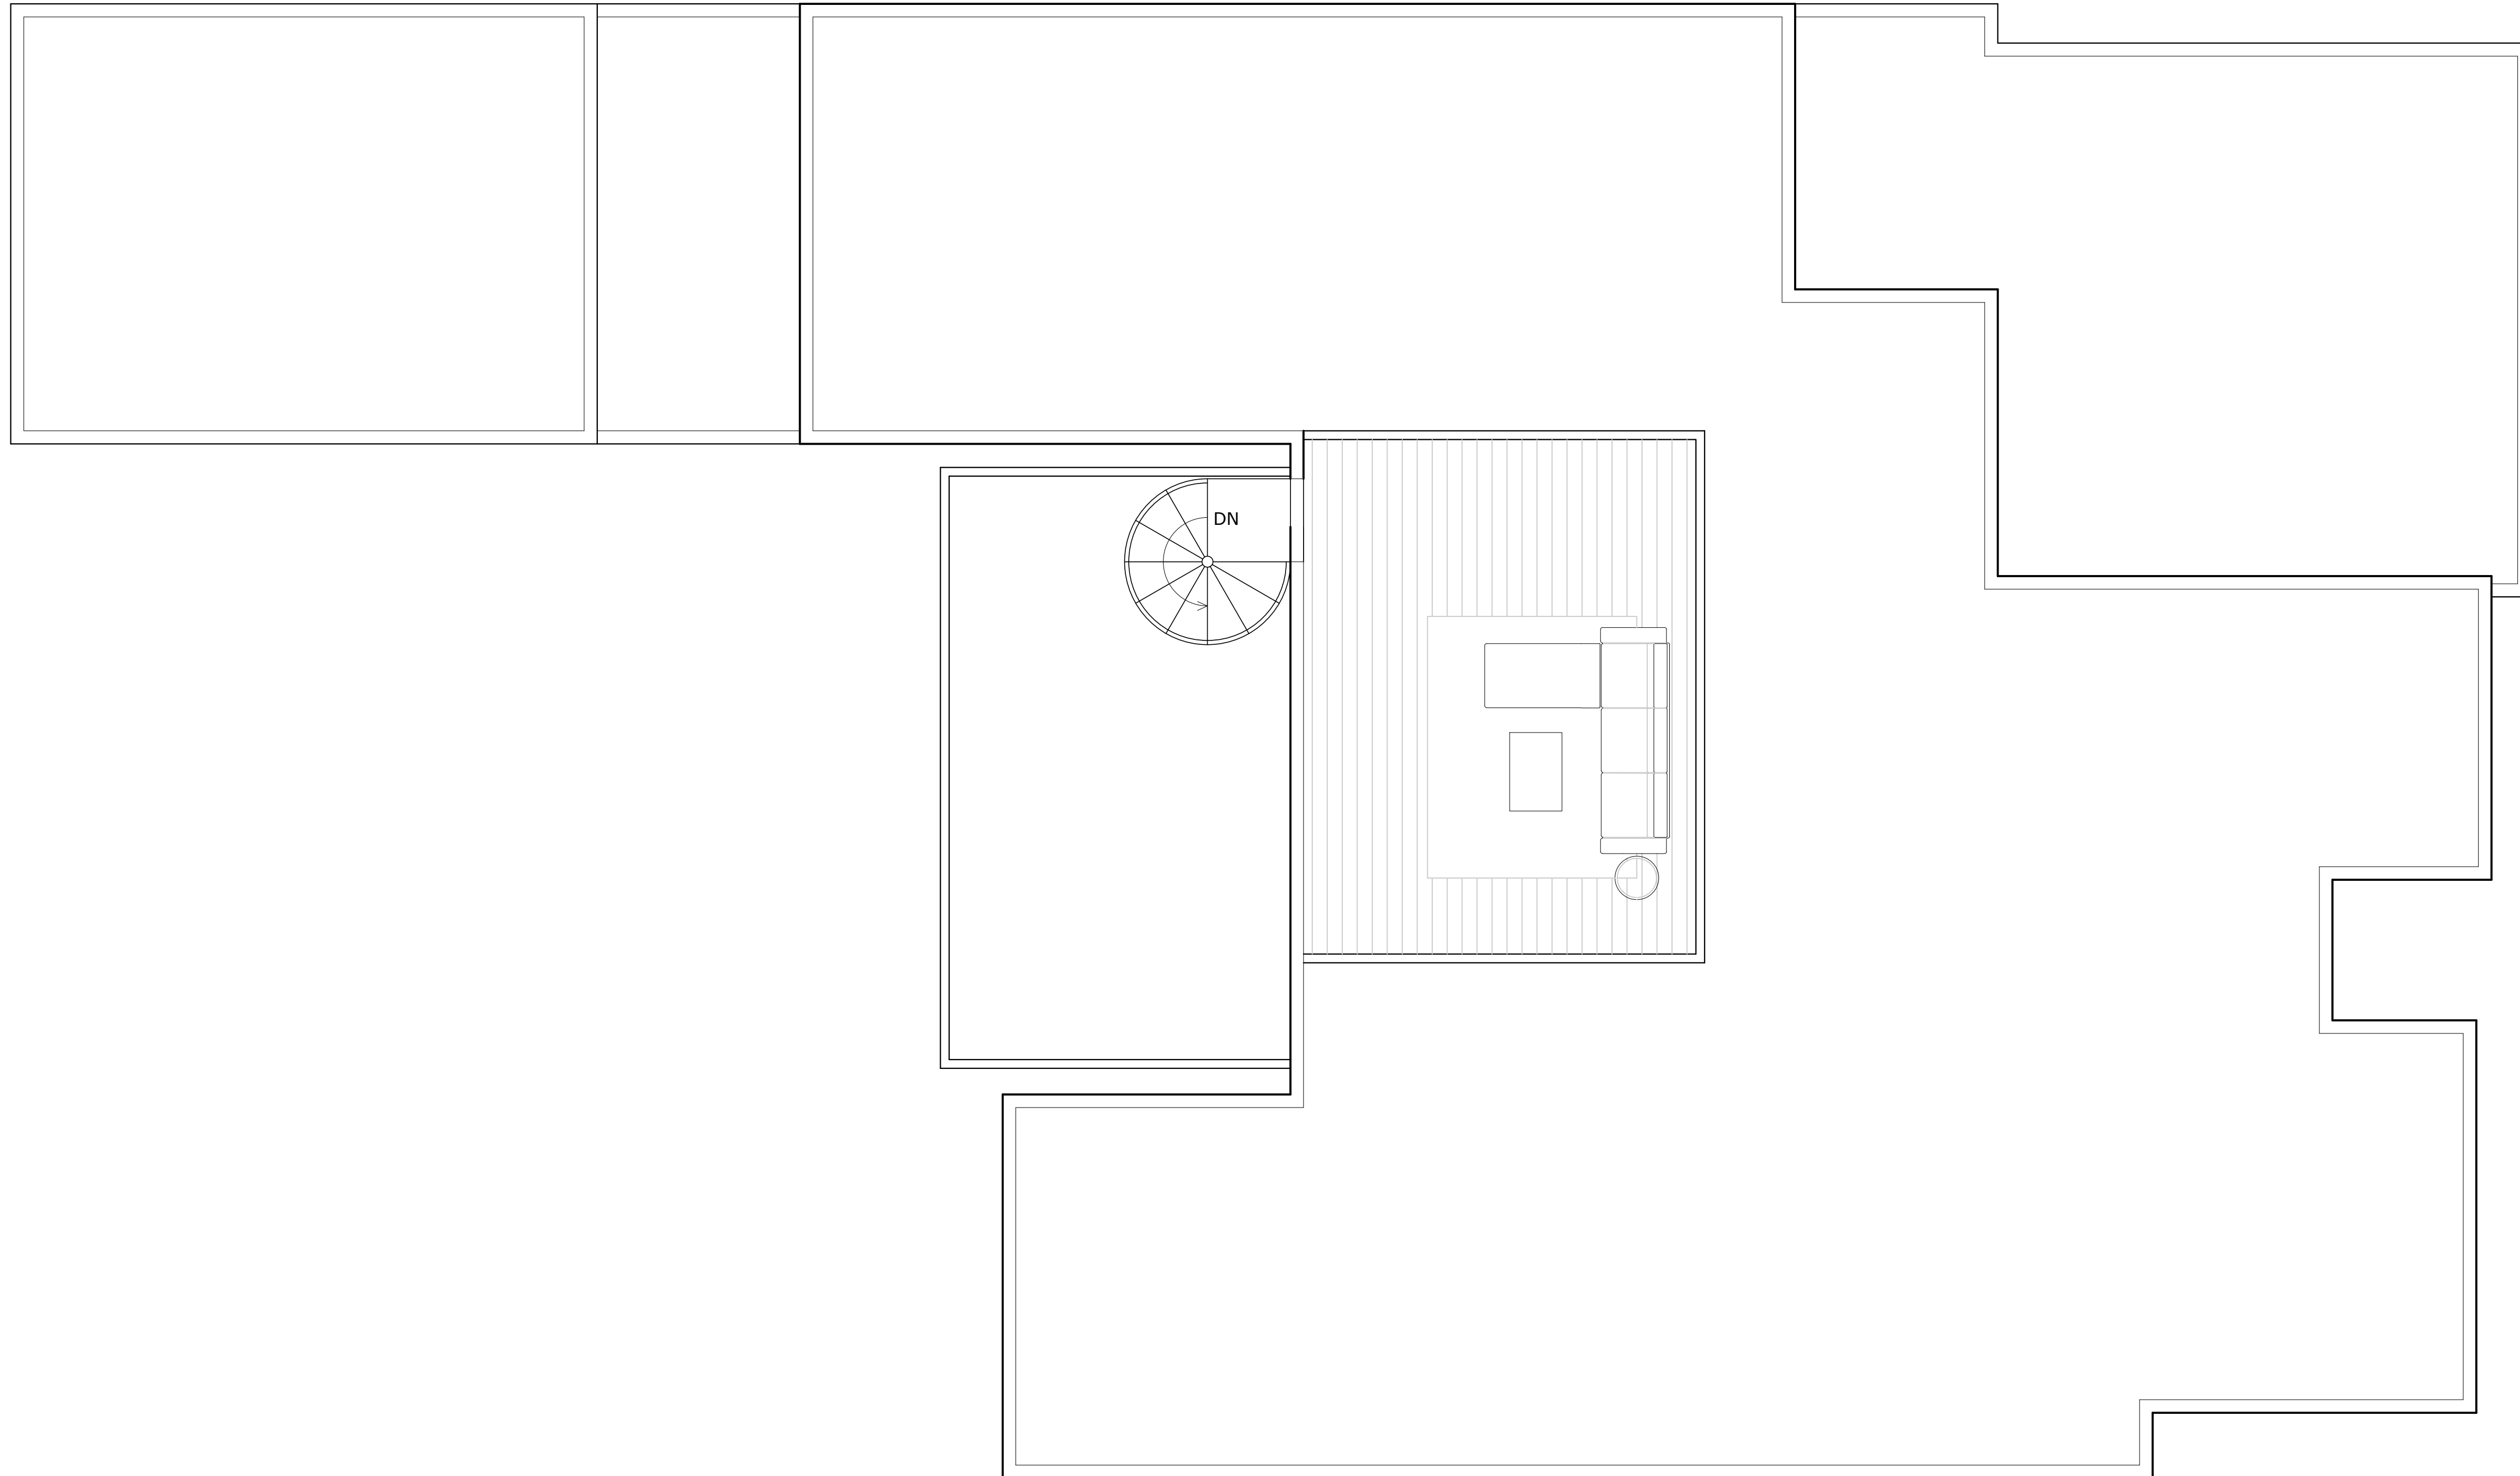PROJECT
2114 PARAMOUNT

OWNER
ATX LUXURY BUILDERS

REVISIONS
 NO ISSUE DATE

NOTES



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SHEET TITLE

ROOF PLAN

SHEET NUMBER

A2.2

NOTE:

1. PROVIDE OVERHEAD ELECTRICAL SERVICE - COORDINATE WITH GENERAL CONTRACTOR FOR LOCATION OF ELECTRICAL METER.


ELECTRICAL NOTES:

- 1) LAYOUT SHOWN IS SCHEMATIC ONLY. ELECTRICAL CONTRACTOR SHALL DESIGN AND FURNISH ELECTRICAL SYSTEM IN CONFORMANCE WITH ALL APPLICABLE CODES.
- 2) COORDINATE WITH HVAC INSTALLER TO PROVIDE POWER FOR ALL MECHANICAL UNITS.
- 4) PROVIDE NEW DISTRIBUTION PANELS AS REQUIRED. COORDINATE LOCATION WITH BUILDING DESIGNER.


FIXTURE SCHEDULE	
BASE BUILDING FIXTURES	
○ LA	4" RECESSED LED DIODE DOWNLIGHT
○ LA1	4" WET RATED RECESSED LED DIODE DOWNLIGHT
○ LA2	4" EXTERIOR RATED RECESSED LED DIODE DOWNLIGHT
○ LS	SURFACE MOUNTED LIGHT (CEILING)
□ LW	SURFACE MOUNTED LIGHT (WALL)
○ LC	EXTERIOR RATED SURFACE MOUNTED LIGHT (CEILING)
□ LW	EXTERIOR RATED SURFACE MOUNTED LIGHT (WALL)
○ LD	SURFACE MOUNTED DIRECTIONAL LIGHT (CEILING)
□ LX	SURFACE MOUNTED STRIP LIGHT
DECORATIVE FIXTURES	
○ D1	FEATURE DINING LIGHT (CEILING)
□ D2	WALL MOUNTED BATHROOM SCONCE
○ D3	KITCHEN ISLAND PENDENT
○ D5	FEATURE ENTRY LIGHT (CEILING)
○ D5	CHANDELIER (CEILING)
FANS	
F1	INTERIOR FAN
F2	EXTERIOR FAN W/O LIGHT
F3	EXHAUST FAN
F4	EXHAUST FAN W/ LIGHT
AUDIO	
SP	SPEAKER

ELECTRICAL LEGEND	
⊕	DUPLEX OUTLET - PROVIDE GFI WHERE REQUIRED BY CODE
⊕ _{3PH}	DUPLEX OUTLET 240 V 3 PHASE
⊕	DUPLEX FLOOR OUTLET
⊕	TELEPHONE/NETWORK/CABLE
⊕	SWITCH
⊕ ²	2-WAY SWITCH
⊕ ^D	DIMMER SWITCH
⊕	GARBAGE DISPOSAL
⊕ ^C	COMBO SWITCH
⊕	GROUND FAULT INTERRUPT OUTLET

NOTES:	
SD	SMOKE DETECTOR INSTALLED IN ACCORDANCE WITH IRC 2012 R314
CM	CARBON MONOXIDE DETECTOR INSTALLED IN ACCORDANCE WITH IRC 2012 R315
HVAC	
⊕	SUPPLY
⊕	RETURN

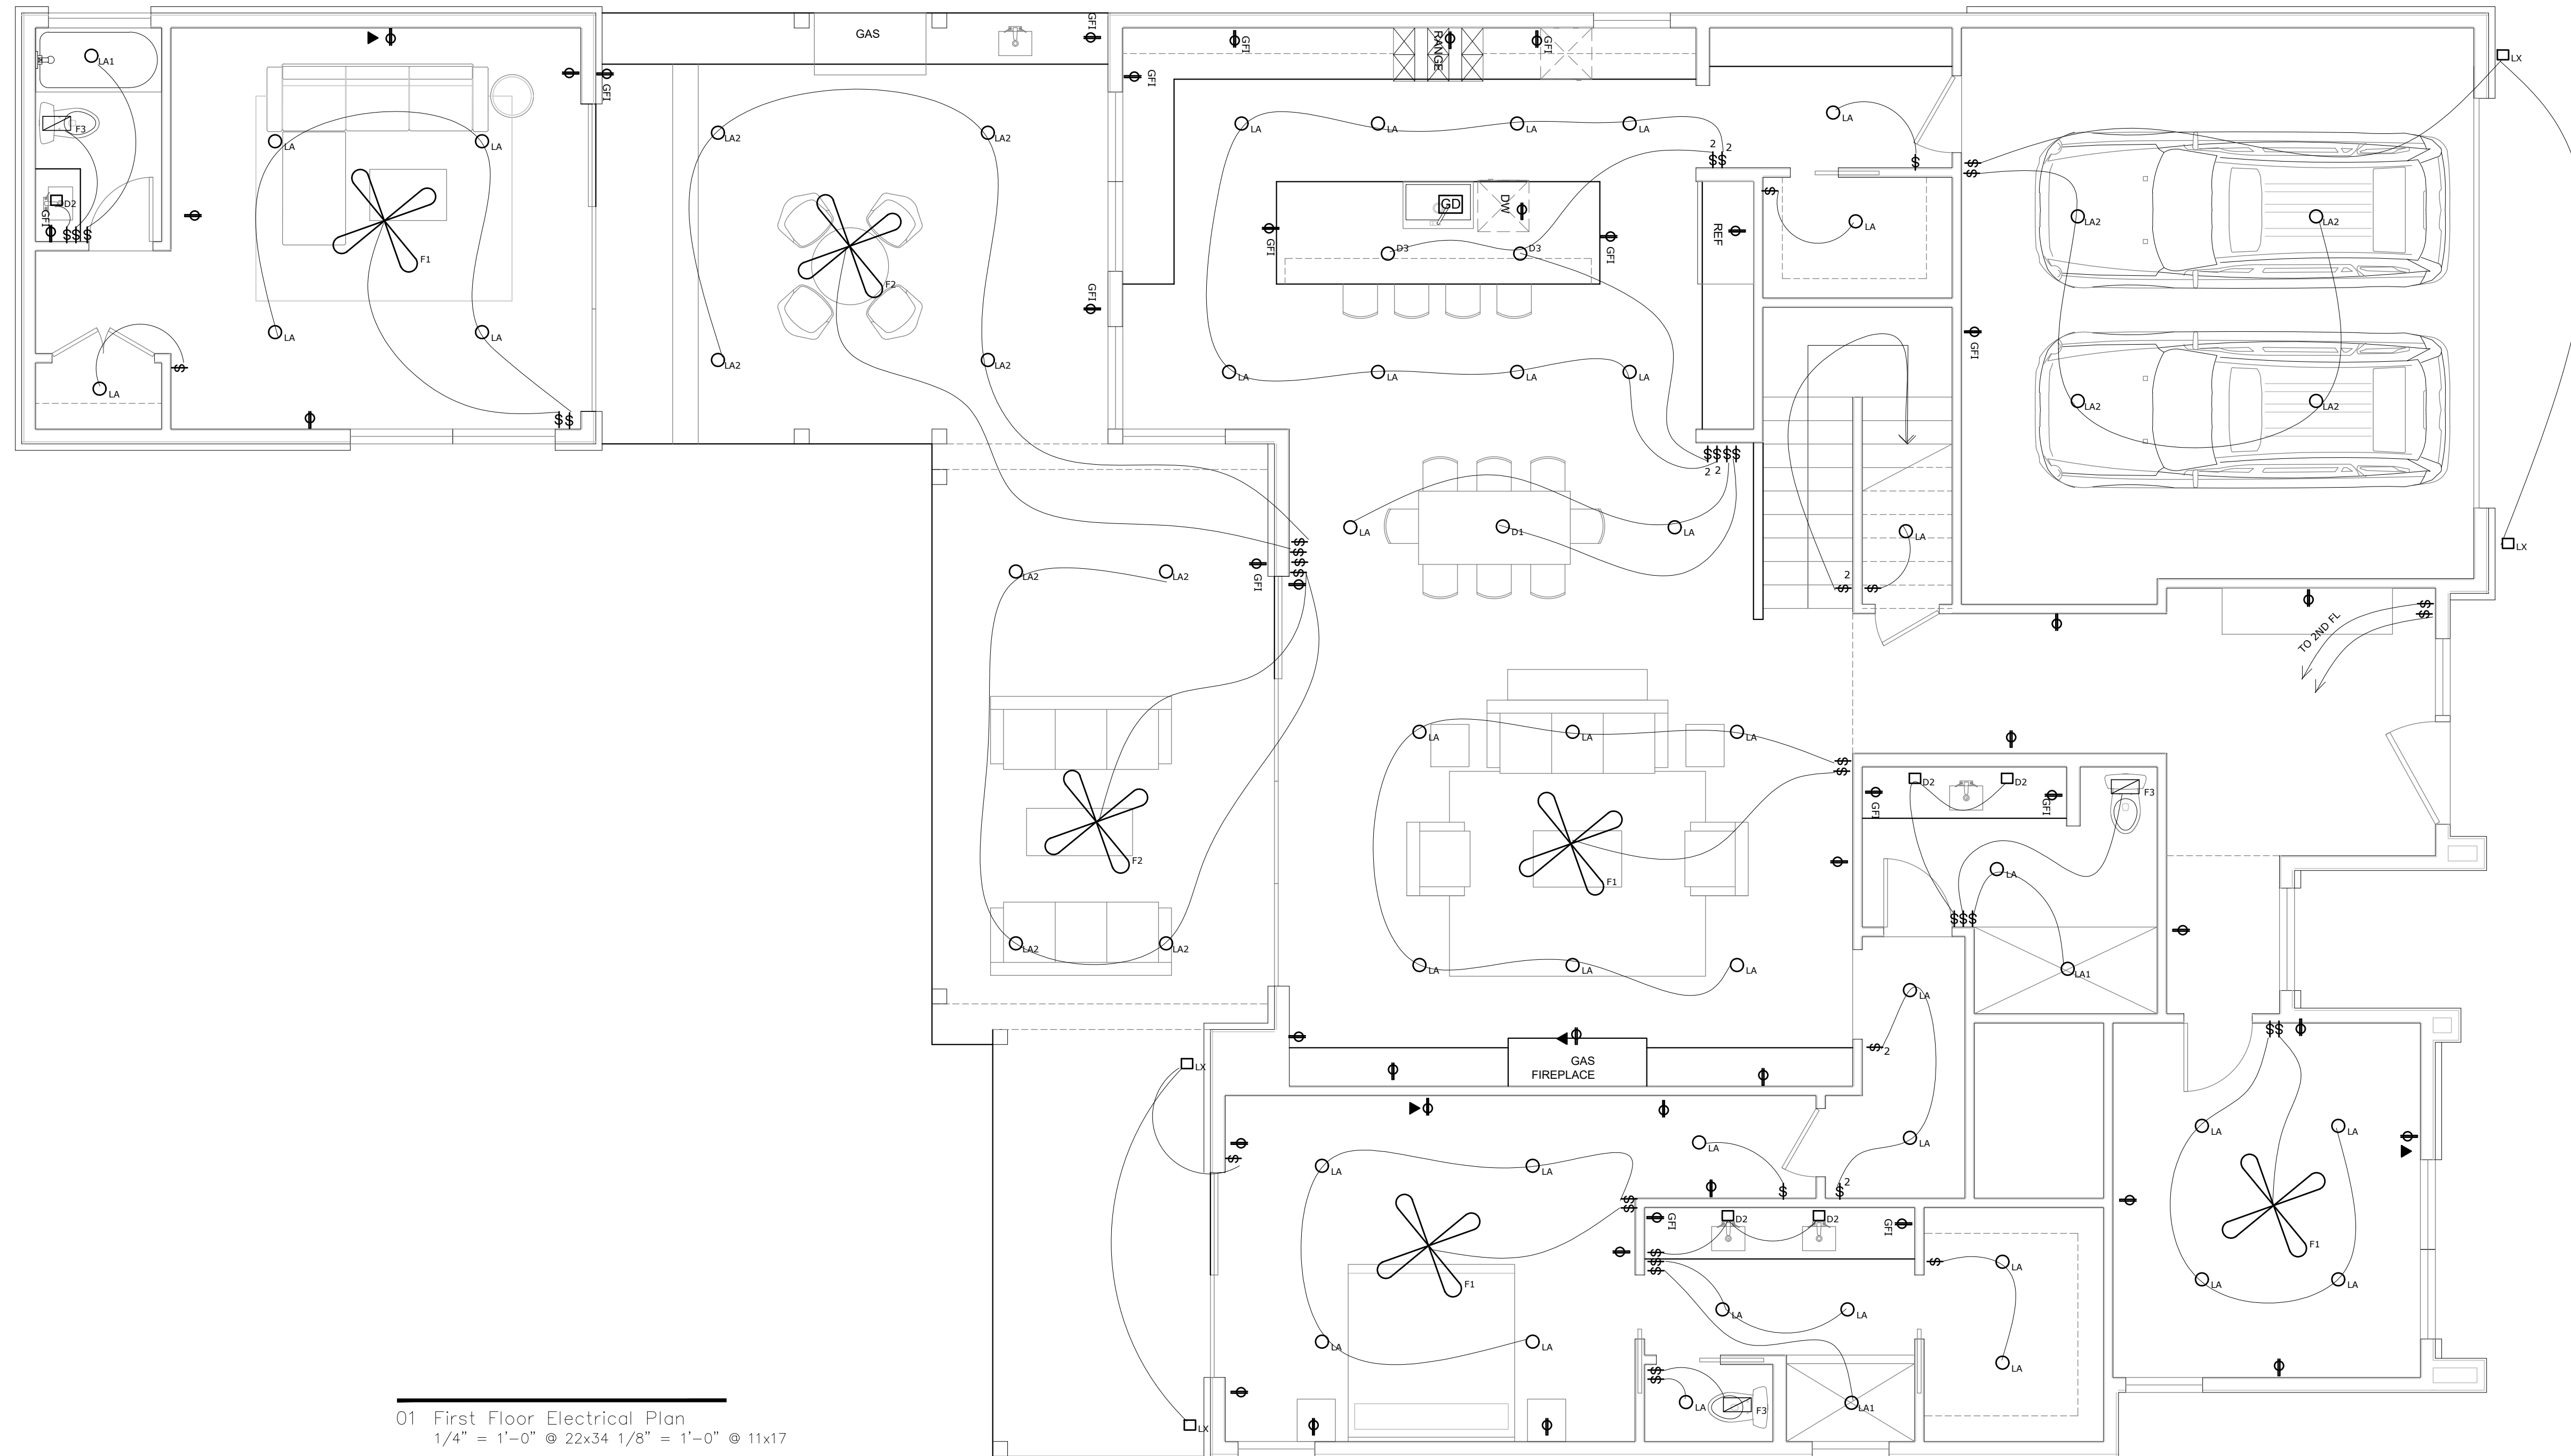

01 First Floor Electrical Plan
1/4" = 1'-0" @ 22x34 1/8" = 1'-0" @ 11x17

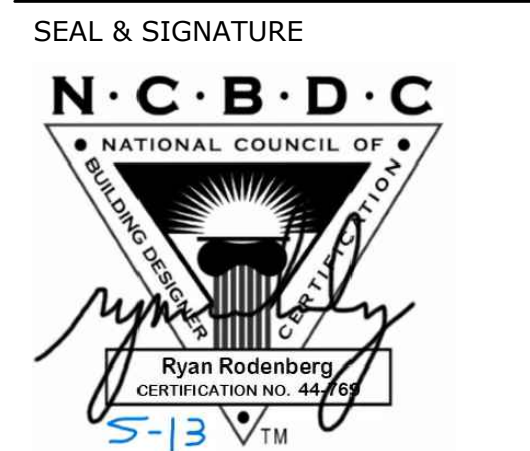

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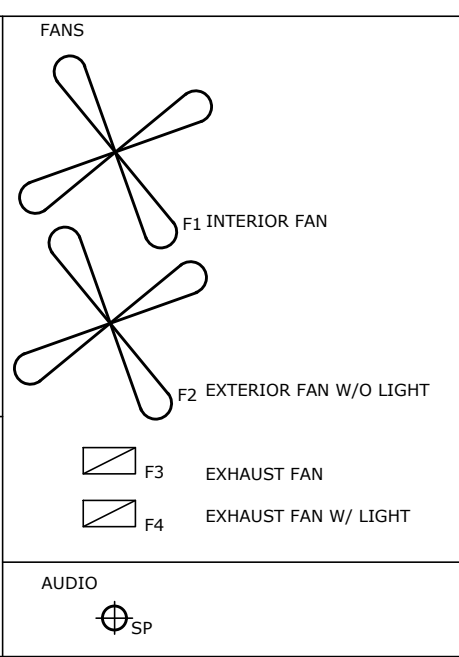
SHEET TITLE

ELECTRICAL PLANS

SHEET NUMBER

A2.4

FIXTURE SCHEDULE	
BASE BUILDING FIXTURES	
○ _{LA}	4" RECESSED LED DIODE DOWNLIGHT
○ _{LA1}	4" WET RATED RECESSED LED DIODE DOWNLIGHT
○ _{LA2}	4" EXTERIOR RATED RECESSED LED DIODE DOWNLIGHT
○ _{LS}	SURFACE MOUNTED LIGHT (CEILING)
□ _{LW}	SURFACE MOUNTED LIGHT (WALL)
○ _{LC}	EXTERIOR RATED SURFACE MOUNTED LIGHT (CEILING)
□ _{LX}	EXTERIOR RATED SURFACE MOUNTED LIGHT (WALL)
○ _{LD}	SURFACE MOUNTED DIRECTIONAL LIGHT (CEILING)
□ _{LX}	SURFACE MOUNTED STRIP LIGHT
DECORATIVE FIXTURES	
□ _{D2}	FEATURE DINING LIGHT (CEILING)
□ _{D3}	WALL MOUNTED BATHROOM SCENCE
○ _{D3}	KITCHEN ISLAND PENDENT
○ _{D5}	FEATURE ENTRY LIGHT (CEILING)
○ _{D5}	CHANDELIER (CEILING)



ELECTRICAL LEGEND	
	DUPLEX OUTLET - PROVIDE GFI WHERE REQUIRED BY CODE
	DUPLEX OUTLET 240 V 3 PHASE
	DUPLEX FLOOR OUTLET
	TELEPHONE/NETWORK/CABLE
	SWITCH
	2-WAY SWITCH
	DIMMER SWITCH
	GARBAGE DISPOSAL
	COMBO SWITCH
	GROUND FAULT INTERRUPT OUTLET

NOTES:	
	SMOKE DETECTOR INSTALLED IN ACCORDANCE WITH IRC 2012 R314
	CARBON MONOXIDE DETECTOR INSTALLED IN ACCORDANCE WITH IRC 2012 R315
HVAC	
	SUPPLY
	RETURN

NOTE:

1. PROVIDE OVERHEAD ELECTRICAL SERVICE - COORDINATE WITH GENERAL CONTRACTOR FOR LOCATION OF ELECTRICAL METER.

ELECTRICAL NOTES:

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- 2] COORDINATE WITH HVAC INSTALLER TO PROVIDE POWER FOR ALL MECHANICAL UNITS.
- 4] PROVIDE NEW DISTRIBUTION PANELS AS REQUIRED, COORDINATE LOCATION WITH BUILDING DESIGNER.


PROJECT
2114 PARAMOUNT

OWNER
 ATX LUXURY BUILDERS


REVISIONS

NO	ISSUE	DATE

NOTES

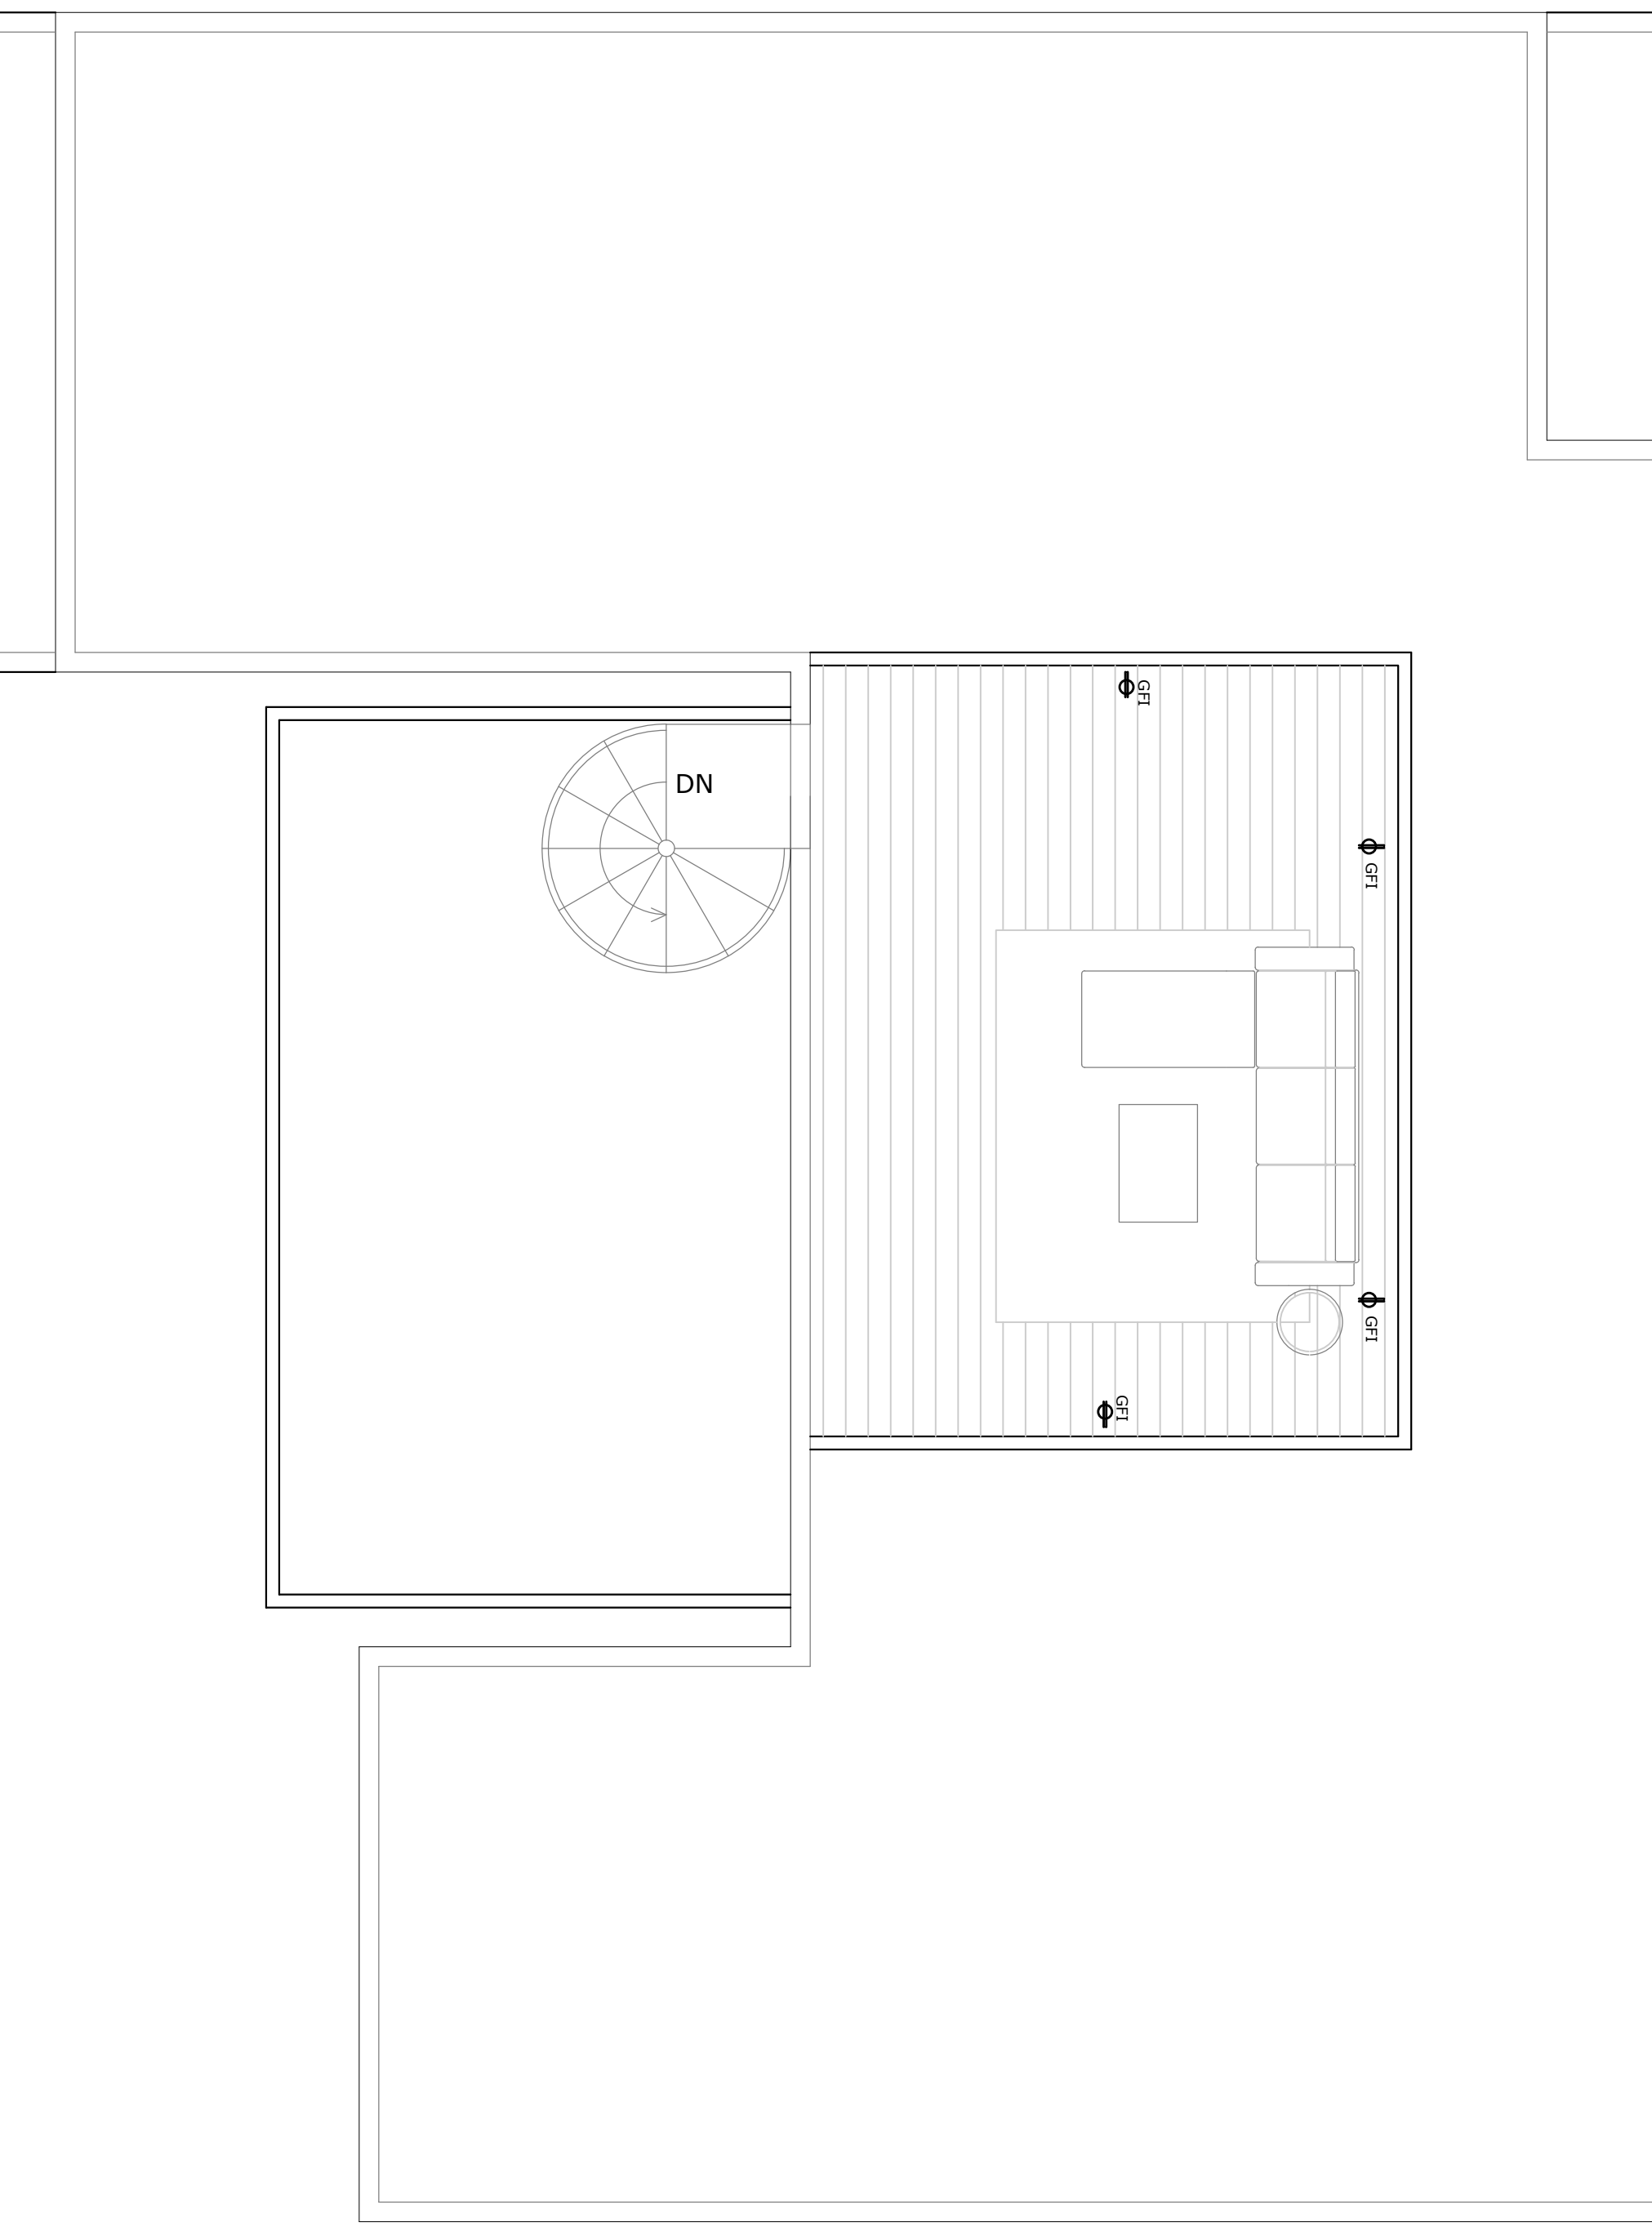

02 ROOF Electrical Plan
 1/4" = 1'-0" @ 22x34 1/8" = 1'-0" @ 11x17

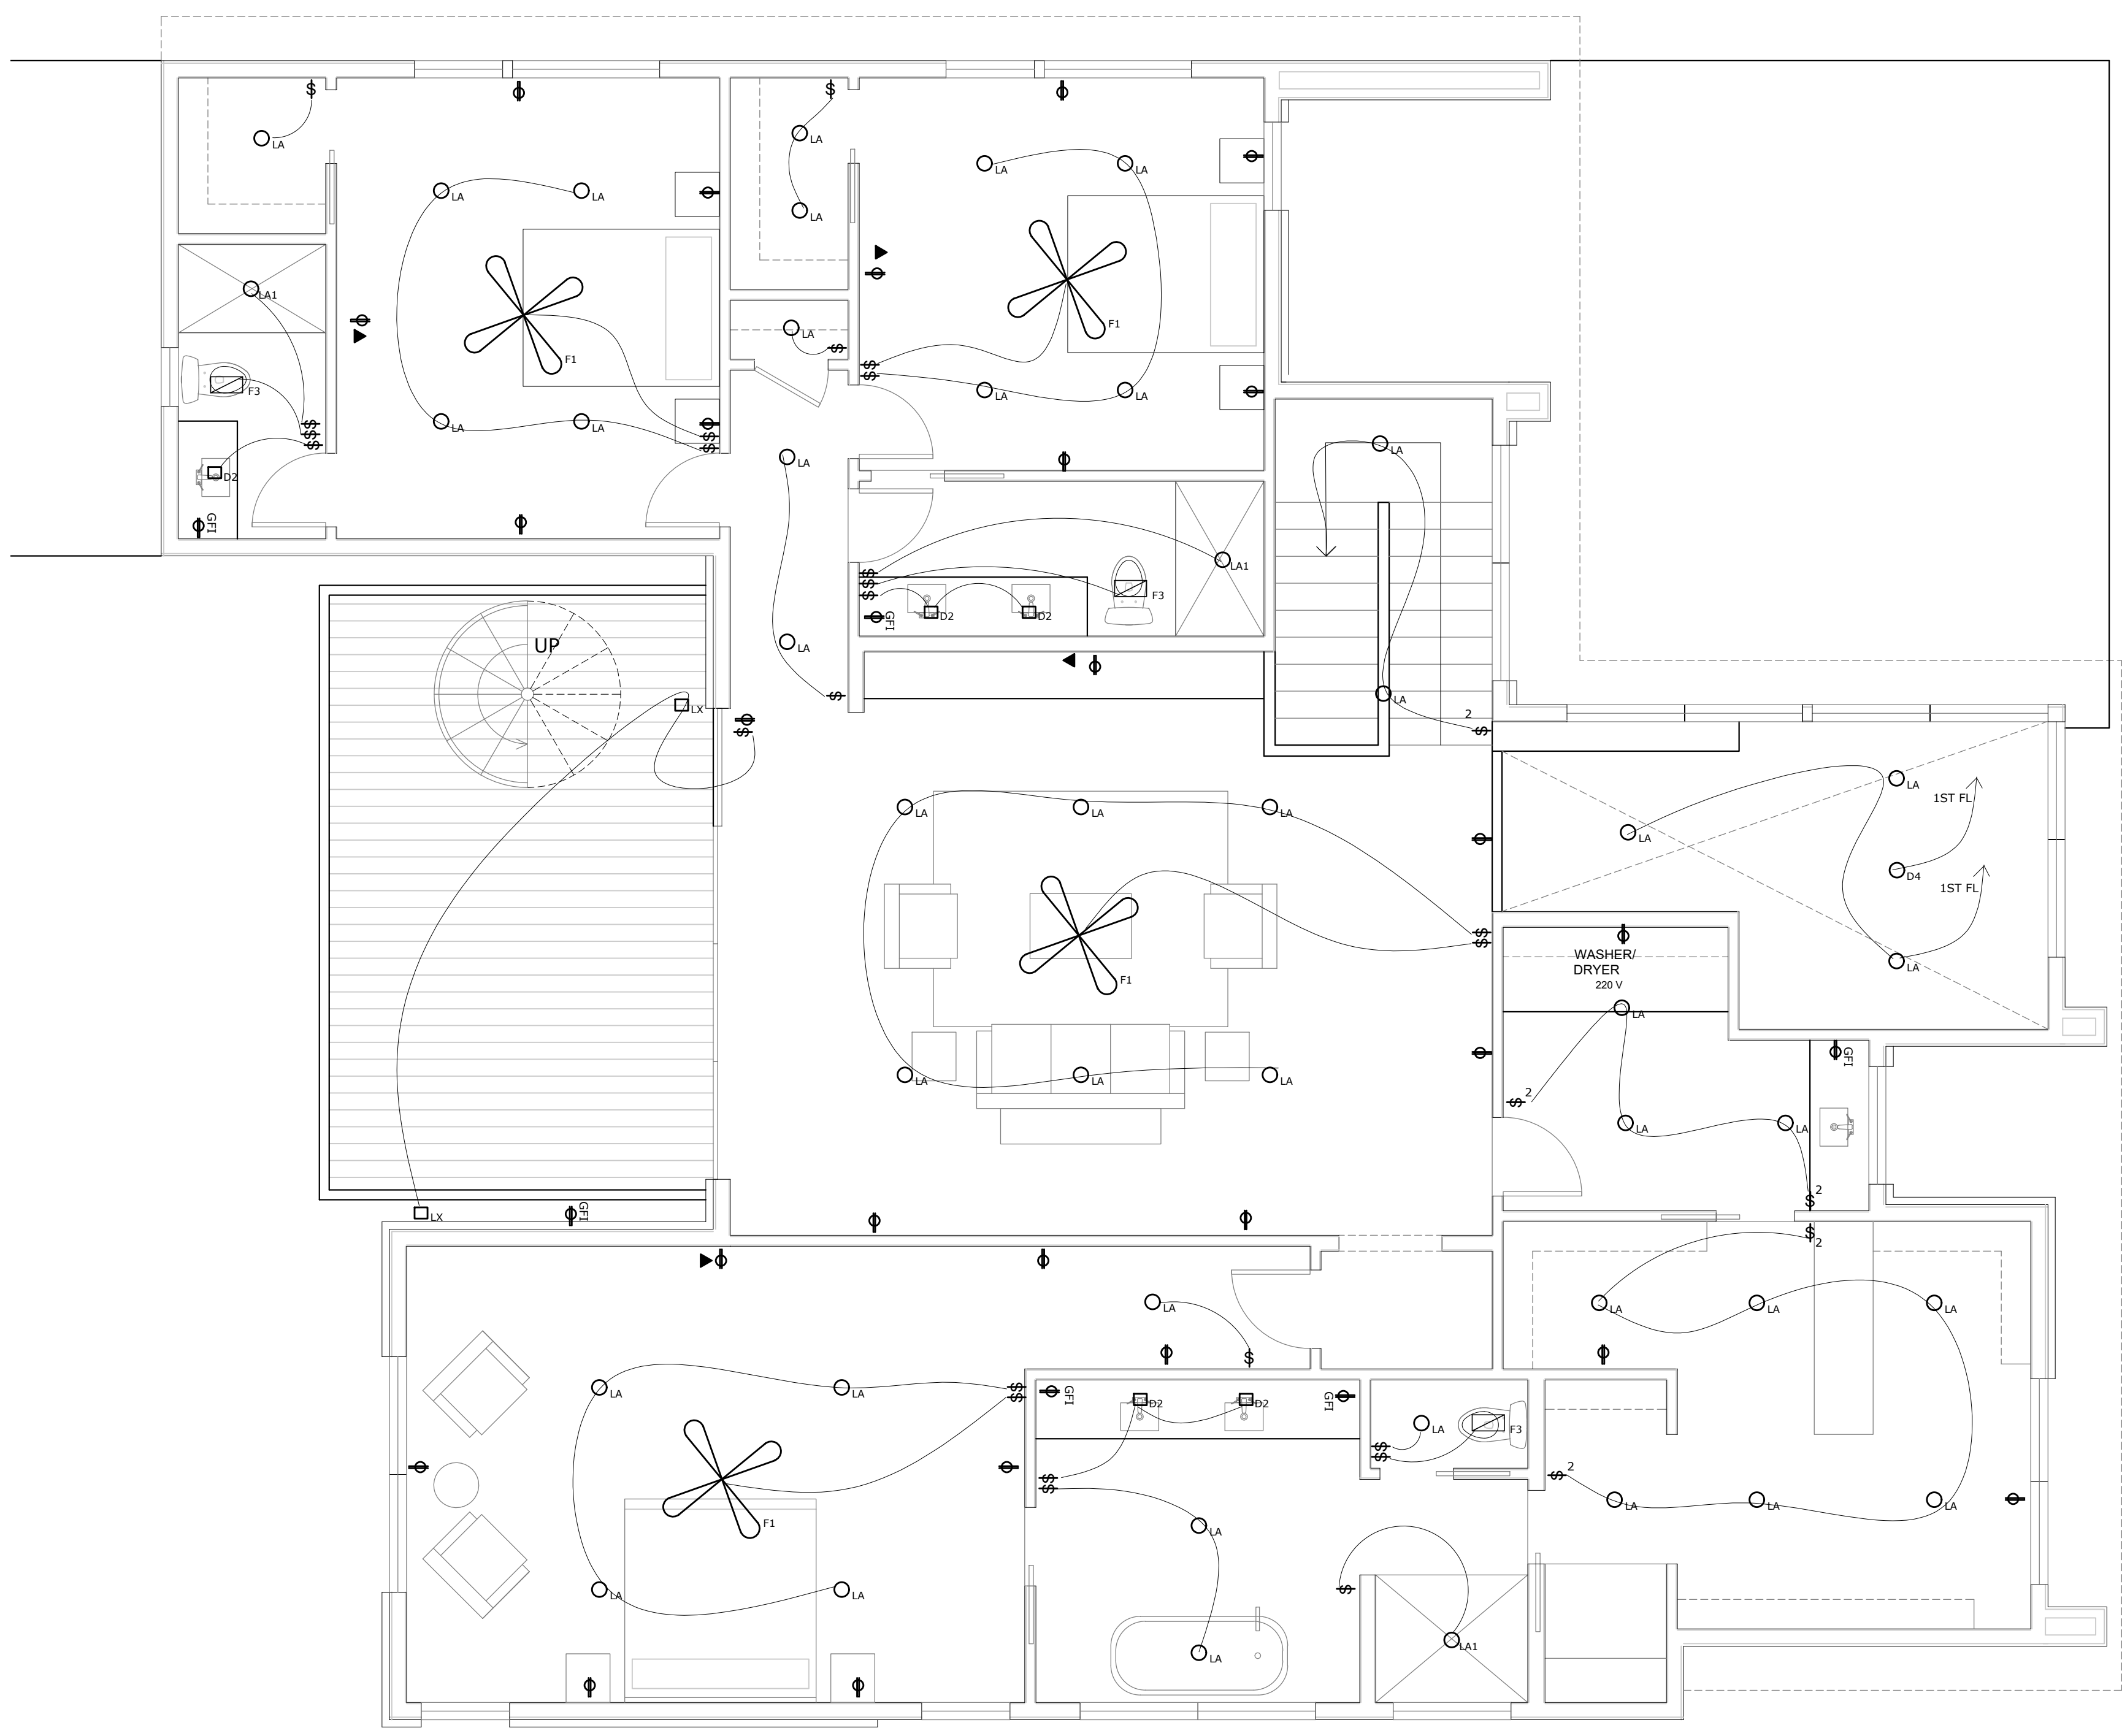

01 Second Floor Electrical Plan
 1/4" = 1'-0" @ 22x34 1/8" = 1'-0" @ 11x17

SEAL & SIGNATURE

DESIGNER

R
 D—0


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SHEET TITLE
 ELECTRICAL PLANS


SHEET NUMBER

A2.5

PLEASE COORDINATE ALL WINDOWS AND DOORS WITH SCHEDULES ON A0.2

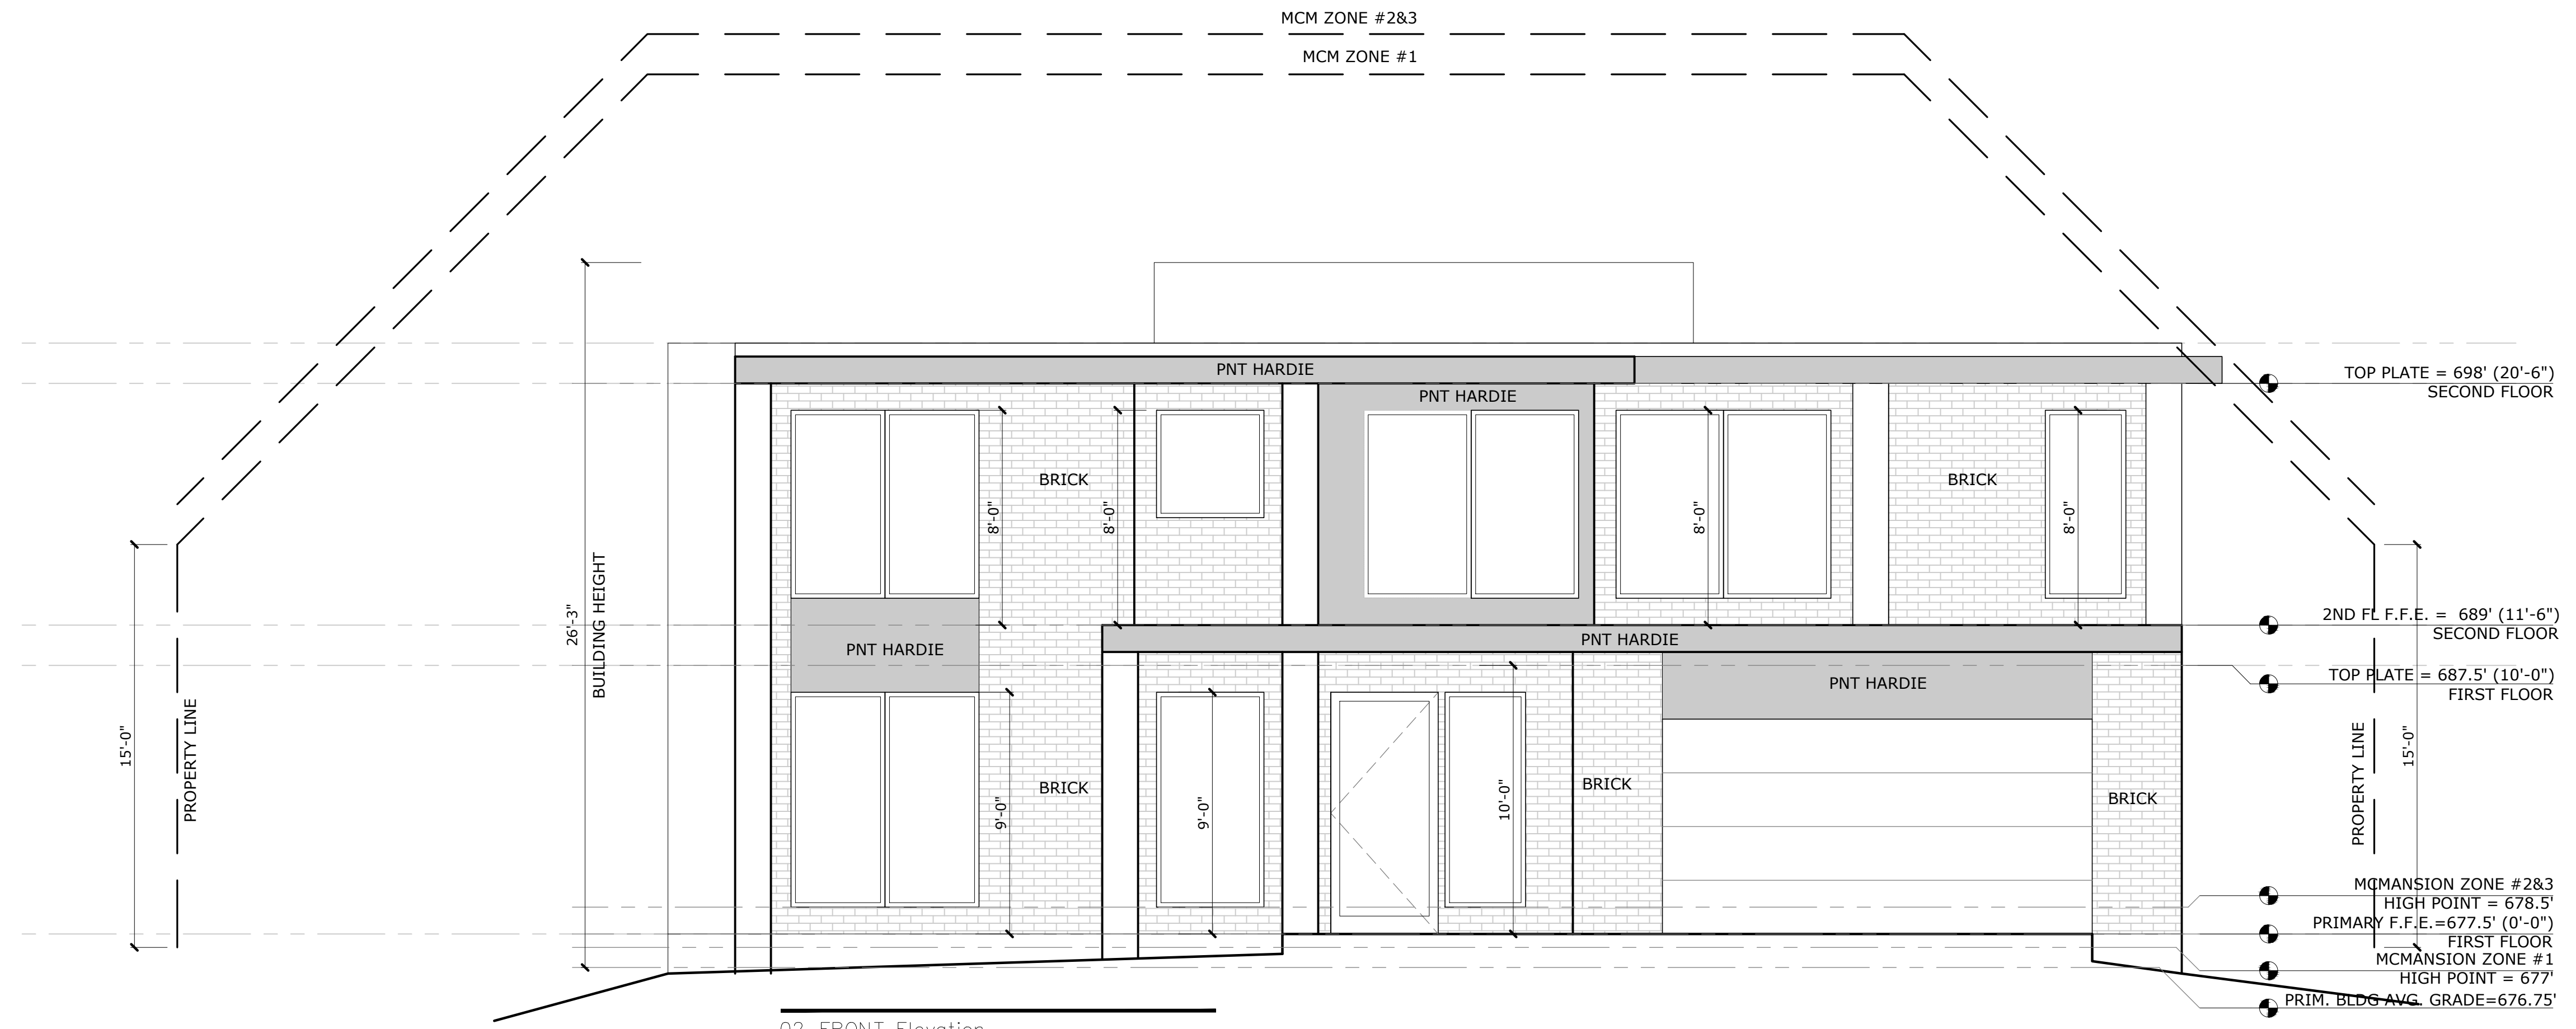

02 FRONT Elevation
 1/4" = 1'-0" @ 22x34 1/8" = 1'-0" @ 11x17

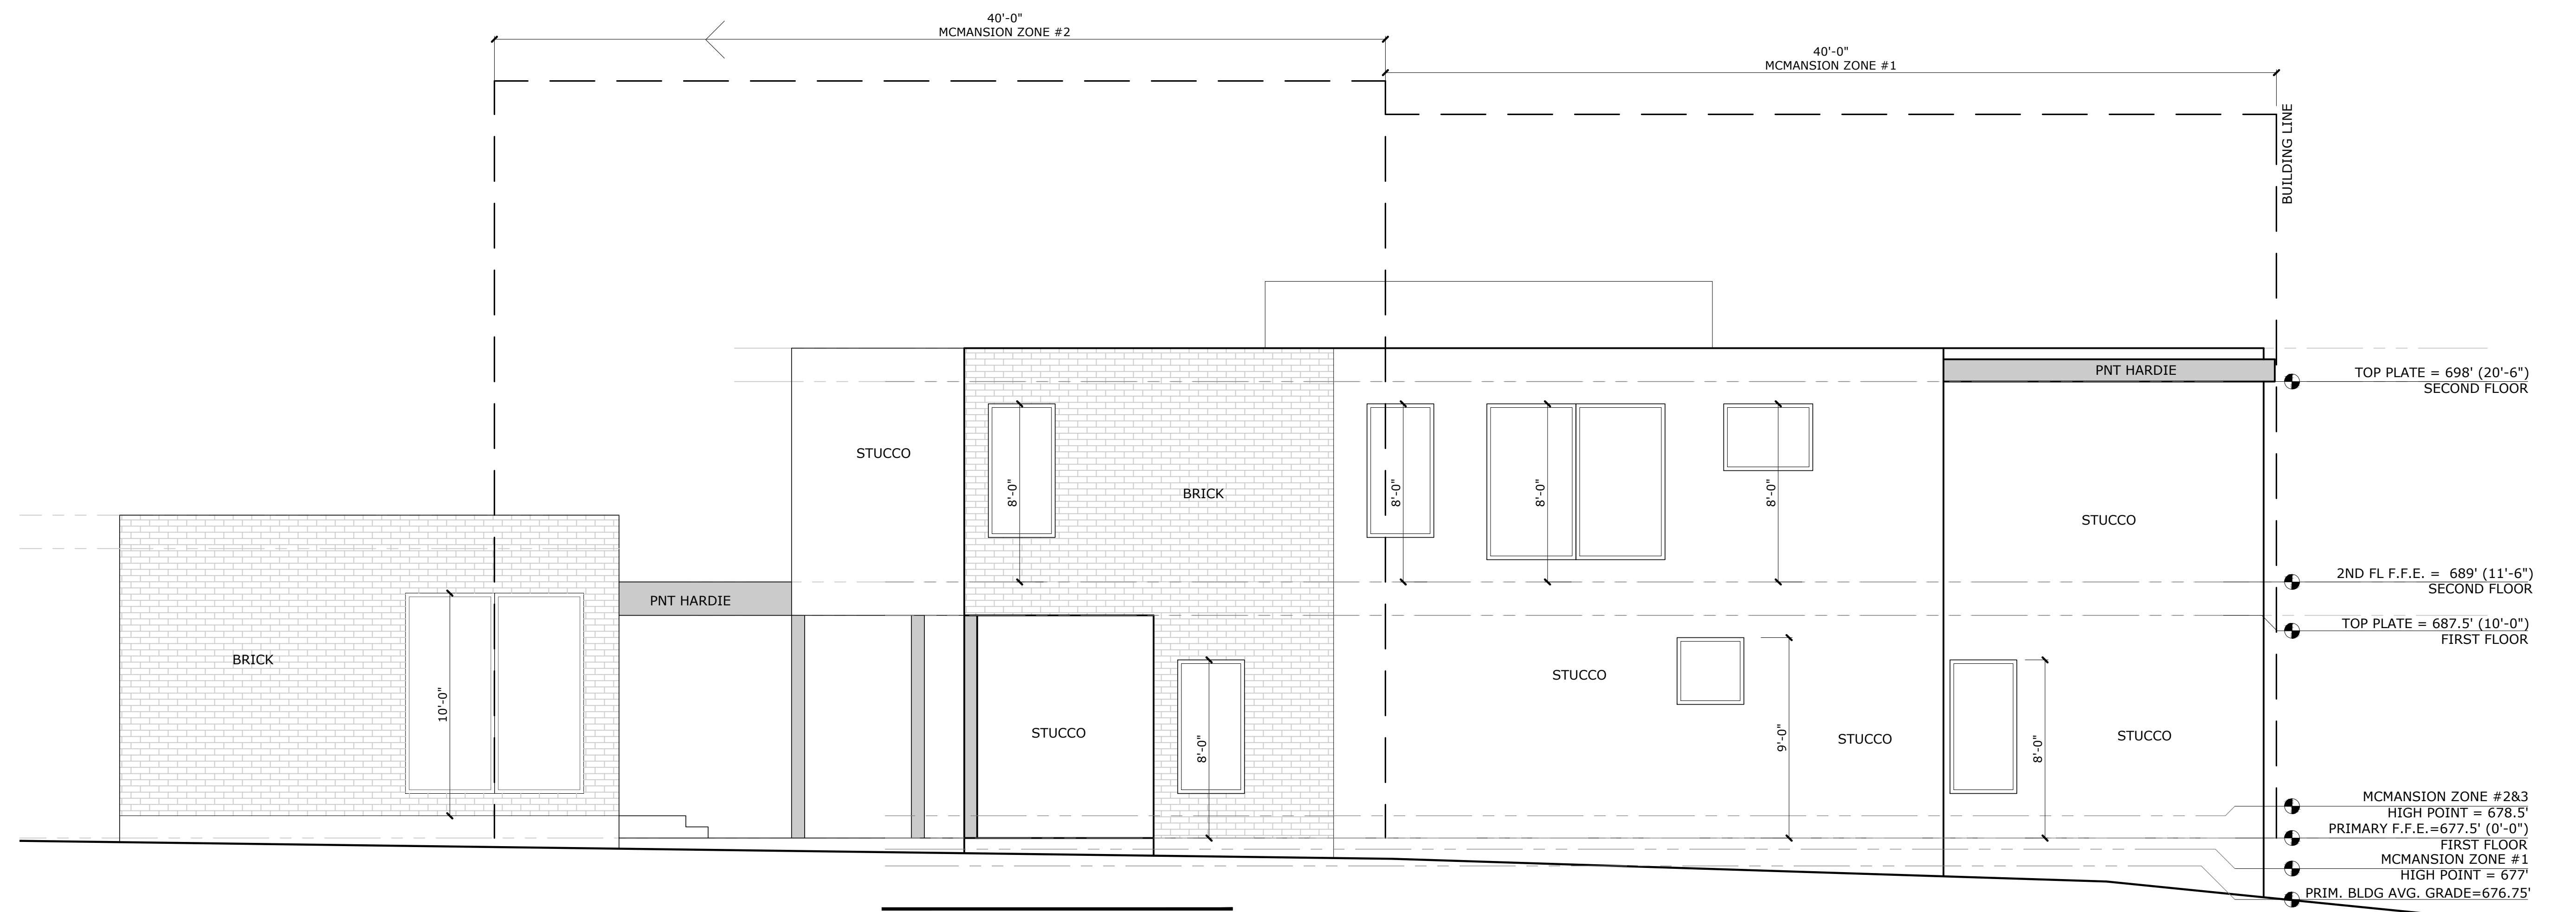

01 LEFT Side
 1/4" = 1'-0" @ 22x34 1/8" = 1'-0" @ 11x17

PROJECT
2114 PARAMOUNT


OWNER

ATX LUXURY BUILDERS

REVISIONS

NO	ISSUE	DATE

NOTES

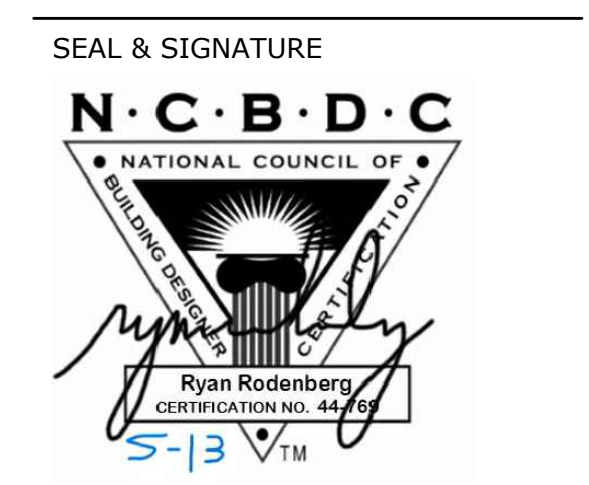

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SHEET TITLE


PRIMARY RESIDENCE
 ELEVATIONS

SHEET NUMBER


A3.0

PLEASE COORDINATE ALL WINDOWS AND DOORS WITH SCHEDULES ON A0.2

MCM ZONE #2&3
MCM ZONE #1

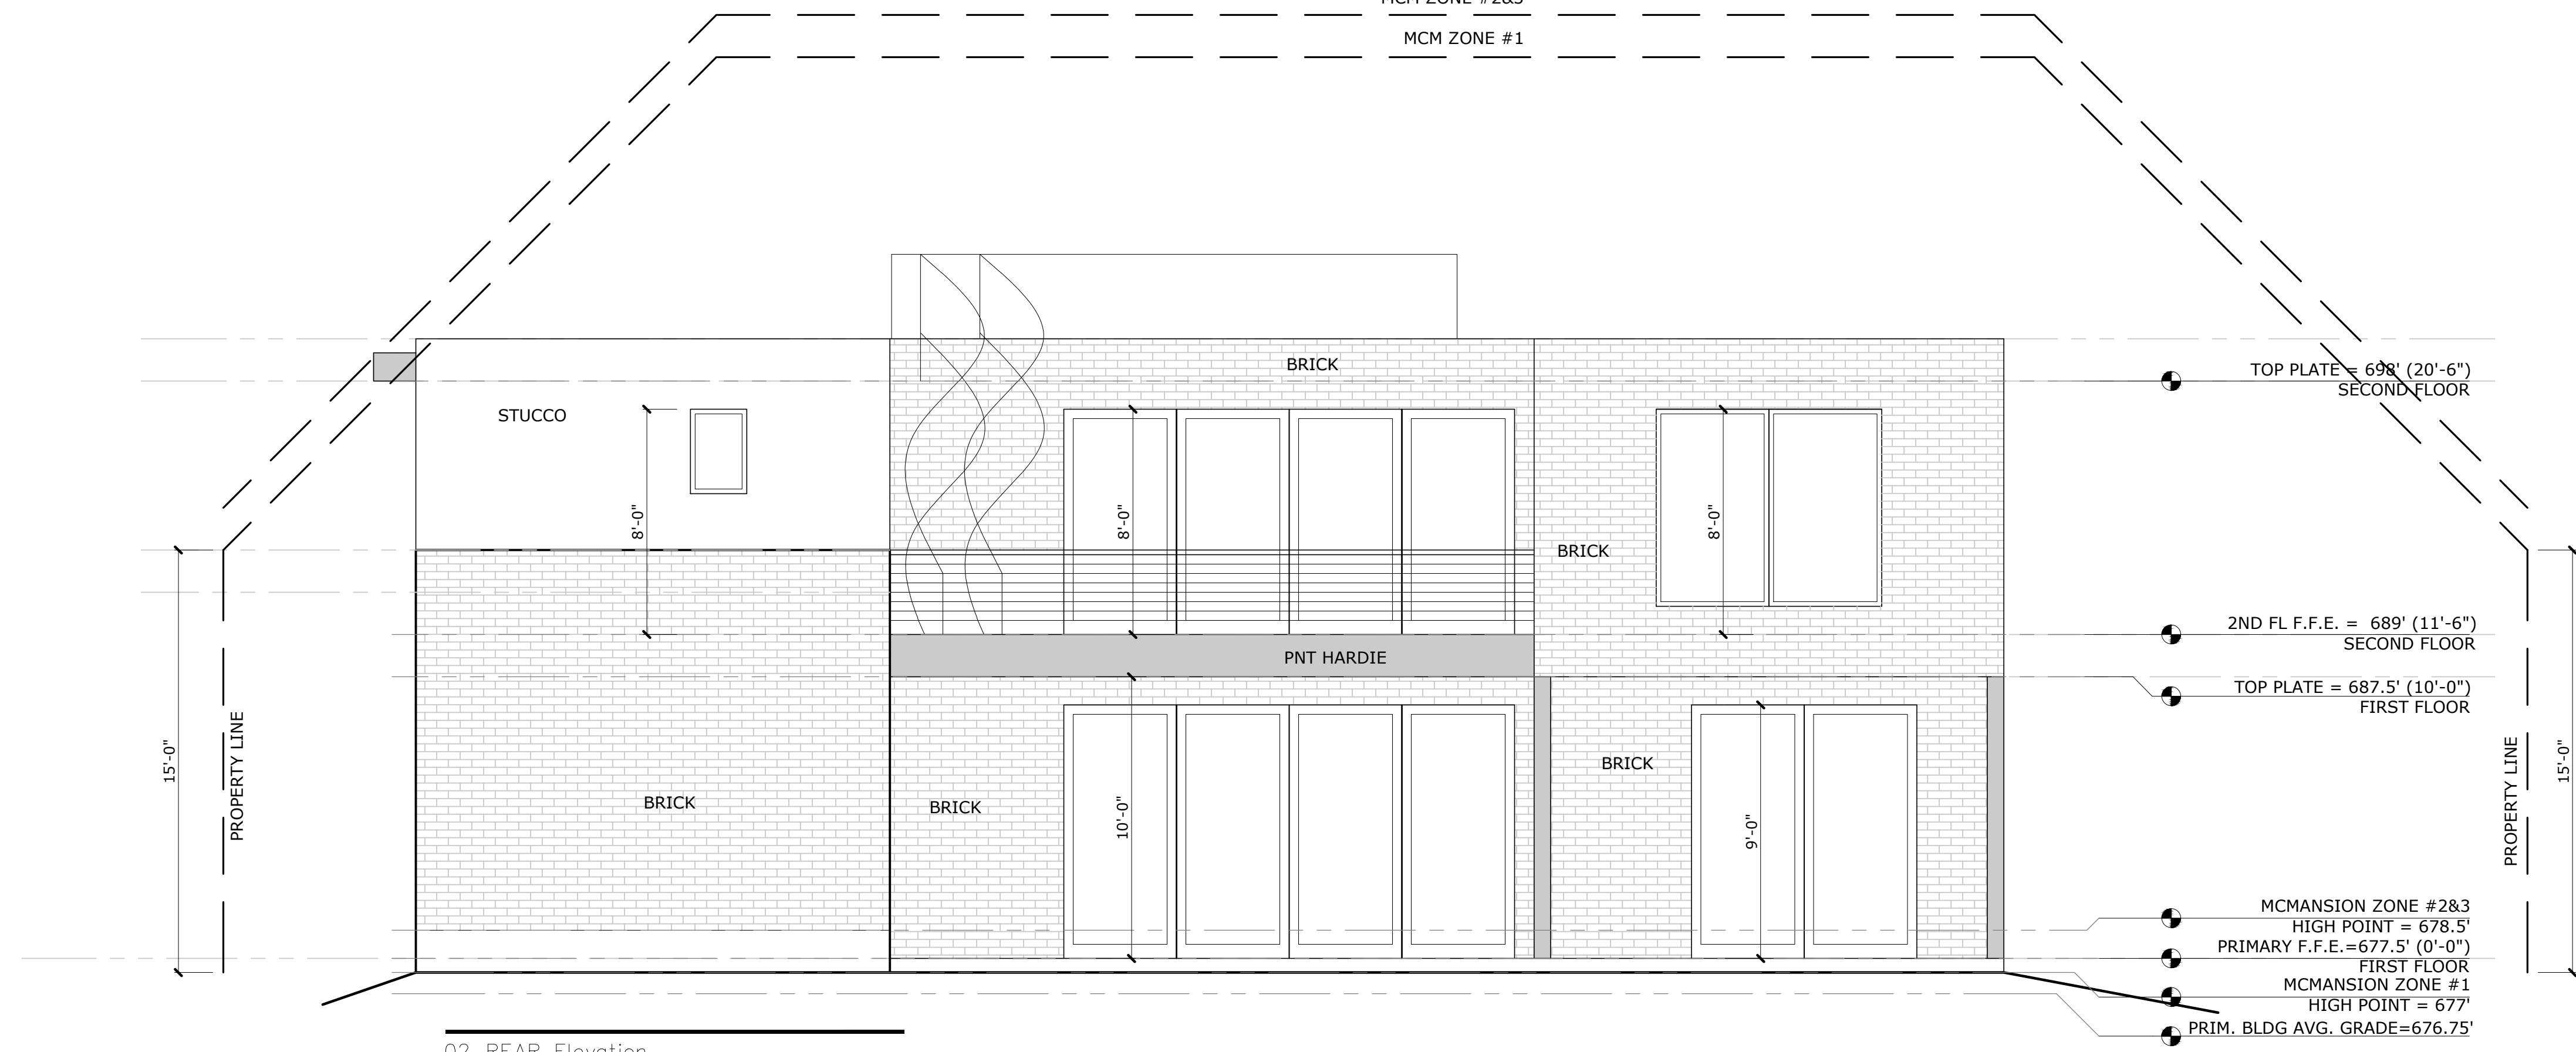

02 REAR Elevation
1/4" = 1'-0" @ 22x34 1/8" = 1'-0" @ 11x17

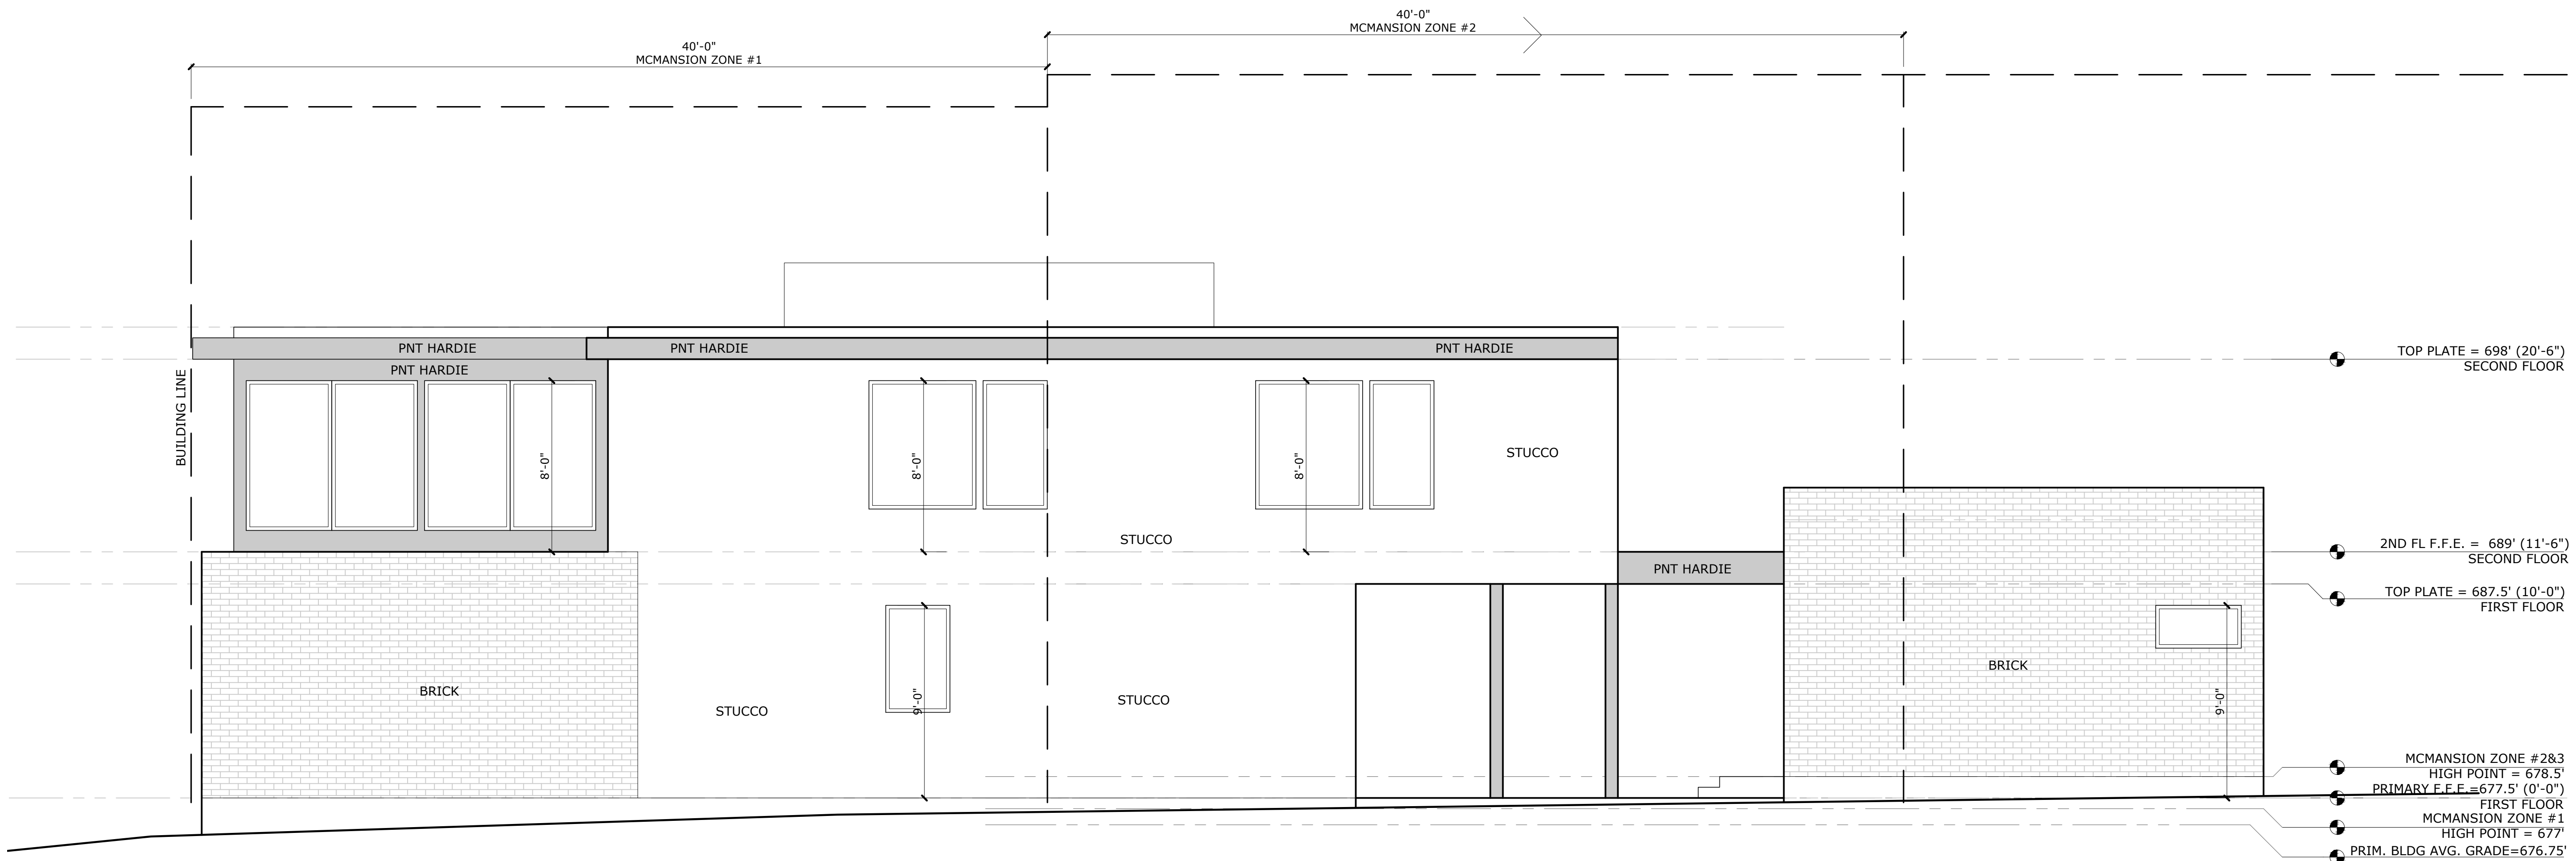

01 RIGHT Elevation
1/4" = 1'-0" @ 22x34 1/8" = 1'-0" @ 11x17

PROJECT
2114 PARAMOUNT
OWNER
ATX LUXURY BUILDERS

REVISIONS		
NO	ISSUE	DATE

NOTES



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SHEET TITLE
PRIMARY RESIDENCE ELEVATIONS

SHEET NUMBER
A3.1